

Office of the Vice President and Chief Financial Officer

Procurement Services https://procurement.ufl.edu/

971 Elmore Drive PO Box 115250 Gainesville, FL 32611-5250 (352) 392-1331 Fax 352-392-8837

March 27, 2020

ADDENDUM NUMBER 4 ON INVITATION TO BID ITB20KO-136

TITLE: IFAS Demonstration Pavilion - Live Oak, FL

Mandatory pre-bid meeting was held March 17, 2020 at 10:00AM at the site. Bid opening is scheduled for April 9, 2020 at 3:00PM.

This addendum shall be considered part of the Contract Documents for the above-mentioned project as though it had been issued at the same time and incorporated integrally therewith. Where provisions of the following supplementary data differ from those of the original Contract documents, this addendum shall govern and take precedence. Bidders are hereby notified that they shall acknowledge receipt of the addendum.

This addendum consists of:

- Change to Section 00100 INSTRUCTION TO BIDDERS, 1.4 BID FORM, Item F
- Responses to contractor questions and requests for clarification
- One (1) page of drawing C-210 referenced in Q12/A12 of responses to contractor questions and requests for clarification
- Eight (8) pages of drawings referenced in Q16/A16 of responses to contractor questions and requests for clarification
- Five (5) pages of Engineer's Addendum dated March 24, 2020
- Fenetex representative contact information: Craig Scott, craig@fenetex.com, 904-437-5168 (office), 904-612-6762 (mobile)

Karen Olitsky Procurement Agent III

PLEASE ACKNOWLEDGE RECEIPT OF THIS ADDENDUM 4 AND RETURN WITH YOUR BID. FAILURE TO ACKNOWLEDGE THIS ADDENDUM COULD CONSTITUTE REJECTION OF YOUR BID.

VENDOR NAME		_
VENDOR ADDRESS		
SIGNATURE		

Change to Section 00100 – INSTRUCTION TO BIDDERS, 1.4 BID FORM, Item F.

Due to the current COVID-19 pandemic situation, the University of Florida will be accepting proposal submissions by email for this solicitation.

An email submission must be made in lieu of paper copies. These emails will not be opened prior to the published deadline of April 9, 2020 at 3pm. Any submissions received after this time will not be accepted.

Submissions should be sent to procurement@ufl.edu

Copied to kolitsk@ufl.edu

To ensure all submissions are received and avoid potential email delays, please do not wait until the deadline to submit your proposals. The proposal submission format should follow that as outlined in the original ITB document, Section 00100 – INSTRUCTION TO BIDDERS, 1.4 BID FORM, and include the Invitation to Bid Construction Acknowledgment Form, Section 00310 Bid Form (REVISED) and list of subcontractors as described in SECTION 00430 – SUBCONTRACTOR LISTING.


Responses to Contractor Questions and Requests for Clarification

- Q1. What is the budget estimate for this project?
 - A1. \$200,000
- Q2. The specifications call for FRP panels. None are shown on the drawings, please clarify where these panels need to be installed.
 - A2. Disregard references to the FRP panels. None are in scope.
- Q3. Specification Section 09960 FRP panels are not in TOC. Please clarify.
 - A3. Disregard references to the FRP panels. None are in scope.
- Q4. The specifications call out for fire extinguishers and AED's. Both are not shown on drawings, please clarify if they are needed on this project.
 - A4. Reference LS1.0. Three (3) fire extinguishers are indicated. Spec 10520 calls for one (1) AED. Owner to supply and Owner to install.
- Q5. Section 10520 subsection 2.C "automatic external defibrillators" states "include the addition of one or more AED 's, with the cabinet(s) specified, furnished, and installed by the project and the device(s) themselves purchased by the project and installed by UF EH&S. Consult with the EH&S during design regarding type/size, quantity, and location(s)." Please clarify this scope of work.

- A5. Reference LS1.0. Three (3) fire extinguishers are indicated. Spec 10520 calls for one (1) AED. Owner to supply and Owner to install.
- Q6. Specification Section 16305 ceiling fans is not on the table of contents, but the specification is in the spec book. On drawing A4. 0 it states "Fans" not in contract. Please clarify this scope of work.
 - A6. The Owner will furnish and install the specified ceiling fan. The contractor is responsible for the electrical serving the fan and fan junction box suitable for the specified fan.
- Q7. The drawings indicate widths that span up to approximately 25ft between columns. Fenetex has advised that Clear Vinyl Roll up curtains are typically installed no wider than about 13ft before they need intermediate columns. Is it the intent to add columns to support the roll up curtains?
 - A7. No. The curtains will not be clear vinyl but a Retractable Insect Screen.
- Q8. Please confirm if the base bid columns are to be standard PEMB columns.
 - A8. Confirmed.
- Q9. Please confirm that ALT 3 will only be taken if ALT 2 is accepted. There is no detail shown for screen curtain track connection to standard PEMB columns (Base Bid).
 - A9. Confirmed.
- Q10. Who is responsible for removing the existing utility poles?
 - A10. The owner will coordinate the removal of the pole, and the installation of the pad mounted transformer. The contractor is responsible for the installation of the conduit from the meter to the transformer and the coordination with the local utility (Suwannee Valley Electric Coop) for the installation of the conductors from the transformer to the meter can. The contractor should contact Suwannee Valley Electric Cooperative to discuss the transformer and underground connection so that they comply with their policies.
- Q11. Please confirm if the local utility company will be providing the transformer and underground connection to the new transformer.
 - A11. Confirmed. Contractor to install conduit from building to transformer. Utility will provide and pull conductors form the meter to the transformer.
- Q12. Please clarify what items from the civil plan are in Lot 1 vs Lot 2.
 - A12. Reference attached plan C-210 clarifying this item.

- Q13. Given the outside condition of the electric water cooler, it is assumed that it should have freeze protection and be heavy duty. Please confirm and provide water specification.
 - A13. Freeze protection is not required.
- Q14. There is not currently a grassing/sod specification. Please clarify sod type & proposed seed type.
 - A14. Bahia sod and seed shall be used at disturbed soils and stormwater basins for Lot 2. Seeding and Sod in Lot 1 is not in contract.
- Q15. On sheet T0.0, the 3D plan shows landscaping. There are not any landscape & irrigation drawings. Please clarify scope if any.
 - A15. Landscaping is not in scope.
- Q16. Addendum #2, Attachment A, contained revised technical specifications and drawings. Drawing T0.0, LSJ.0, A1.0, A1.2, A2.0, A2.1, A4.0 & A7.0 will not print to scale. These files are sized different. Can new files to scale be distributed?
 - A16. Yes. Reference attached architectural pdfs.
- Q17. Will structural drawings be available before time of bid?
 - A17. Structural drawings for the metal building will not be available prior to the bid. Structural design for the slab will be provided by structural engineer once the metal building manufacturer provides the reactions. This will all be after award of contact.
- Q18. Will the GC be responsible for the testing and inspections of this project?
 - A18. Yes.
- Q19. Specification Section 00811 subsection 1.2 calls for Davis Bacon wages. Please confirm if this applies to this project.
 - A19. Does not apply to this project.
- Q20. Specification Section 01014, 1.7, Personnel Screening. What are the costs associated with the universities screening policy? Please advise.
 - A20. Personnel Screening is not required at this UF IFAS facility.
- Q21. Are there permitting costs associated with UF's building permits? If so, will the contractor be responsible for paying the building permit?
 - A21. Yes. See permit fee schedule in the link below:
 http://www.ehs.ufl.edu/programs/buildcode/codes/fees/
 Contractor is responsible for permitting costs.

- Q22. Does specification Section 01352 LEED Requirements pertain to this project?
 - A22. No.
- Q23. What are the liquidated damages on this project?
 - A23. No liquidated damages on this project.
- Q24. Are barriers required during construction per Section 01530?
 - A24. No.
- Q25. Will a University of Florida exterior building sign be included in this project? Shown in specifications, but none on drawings.
 - A25. Owner will furnish and install sign.

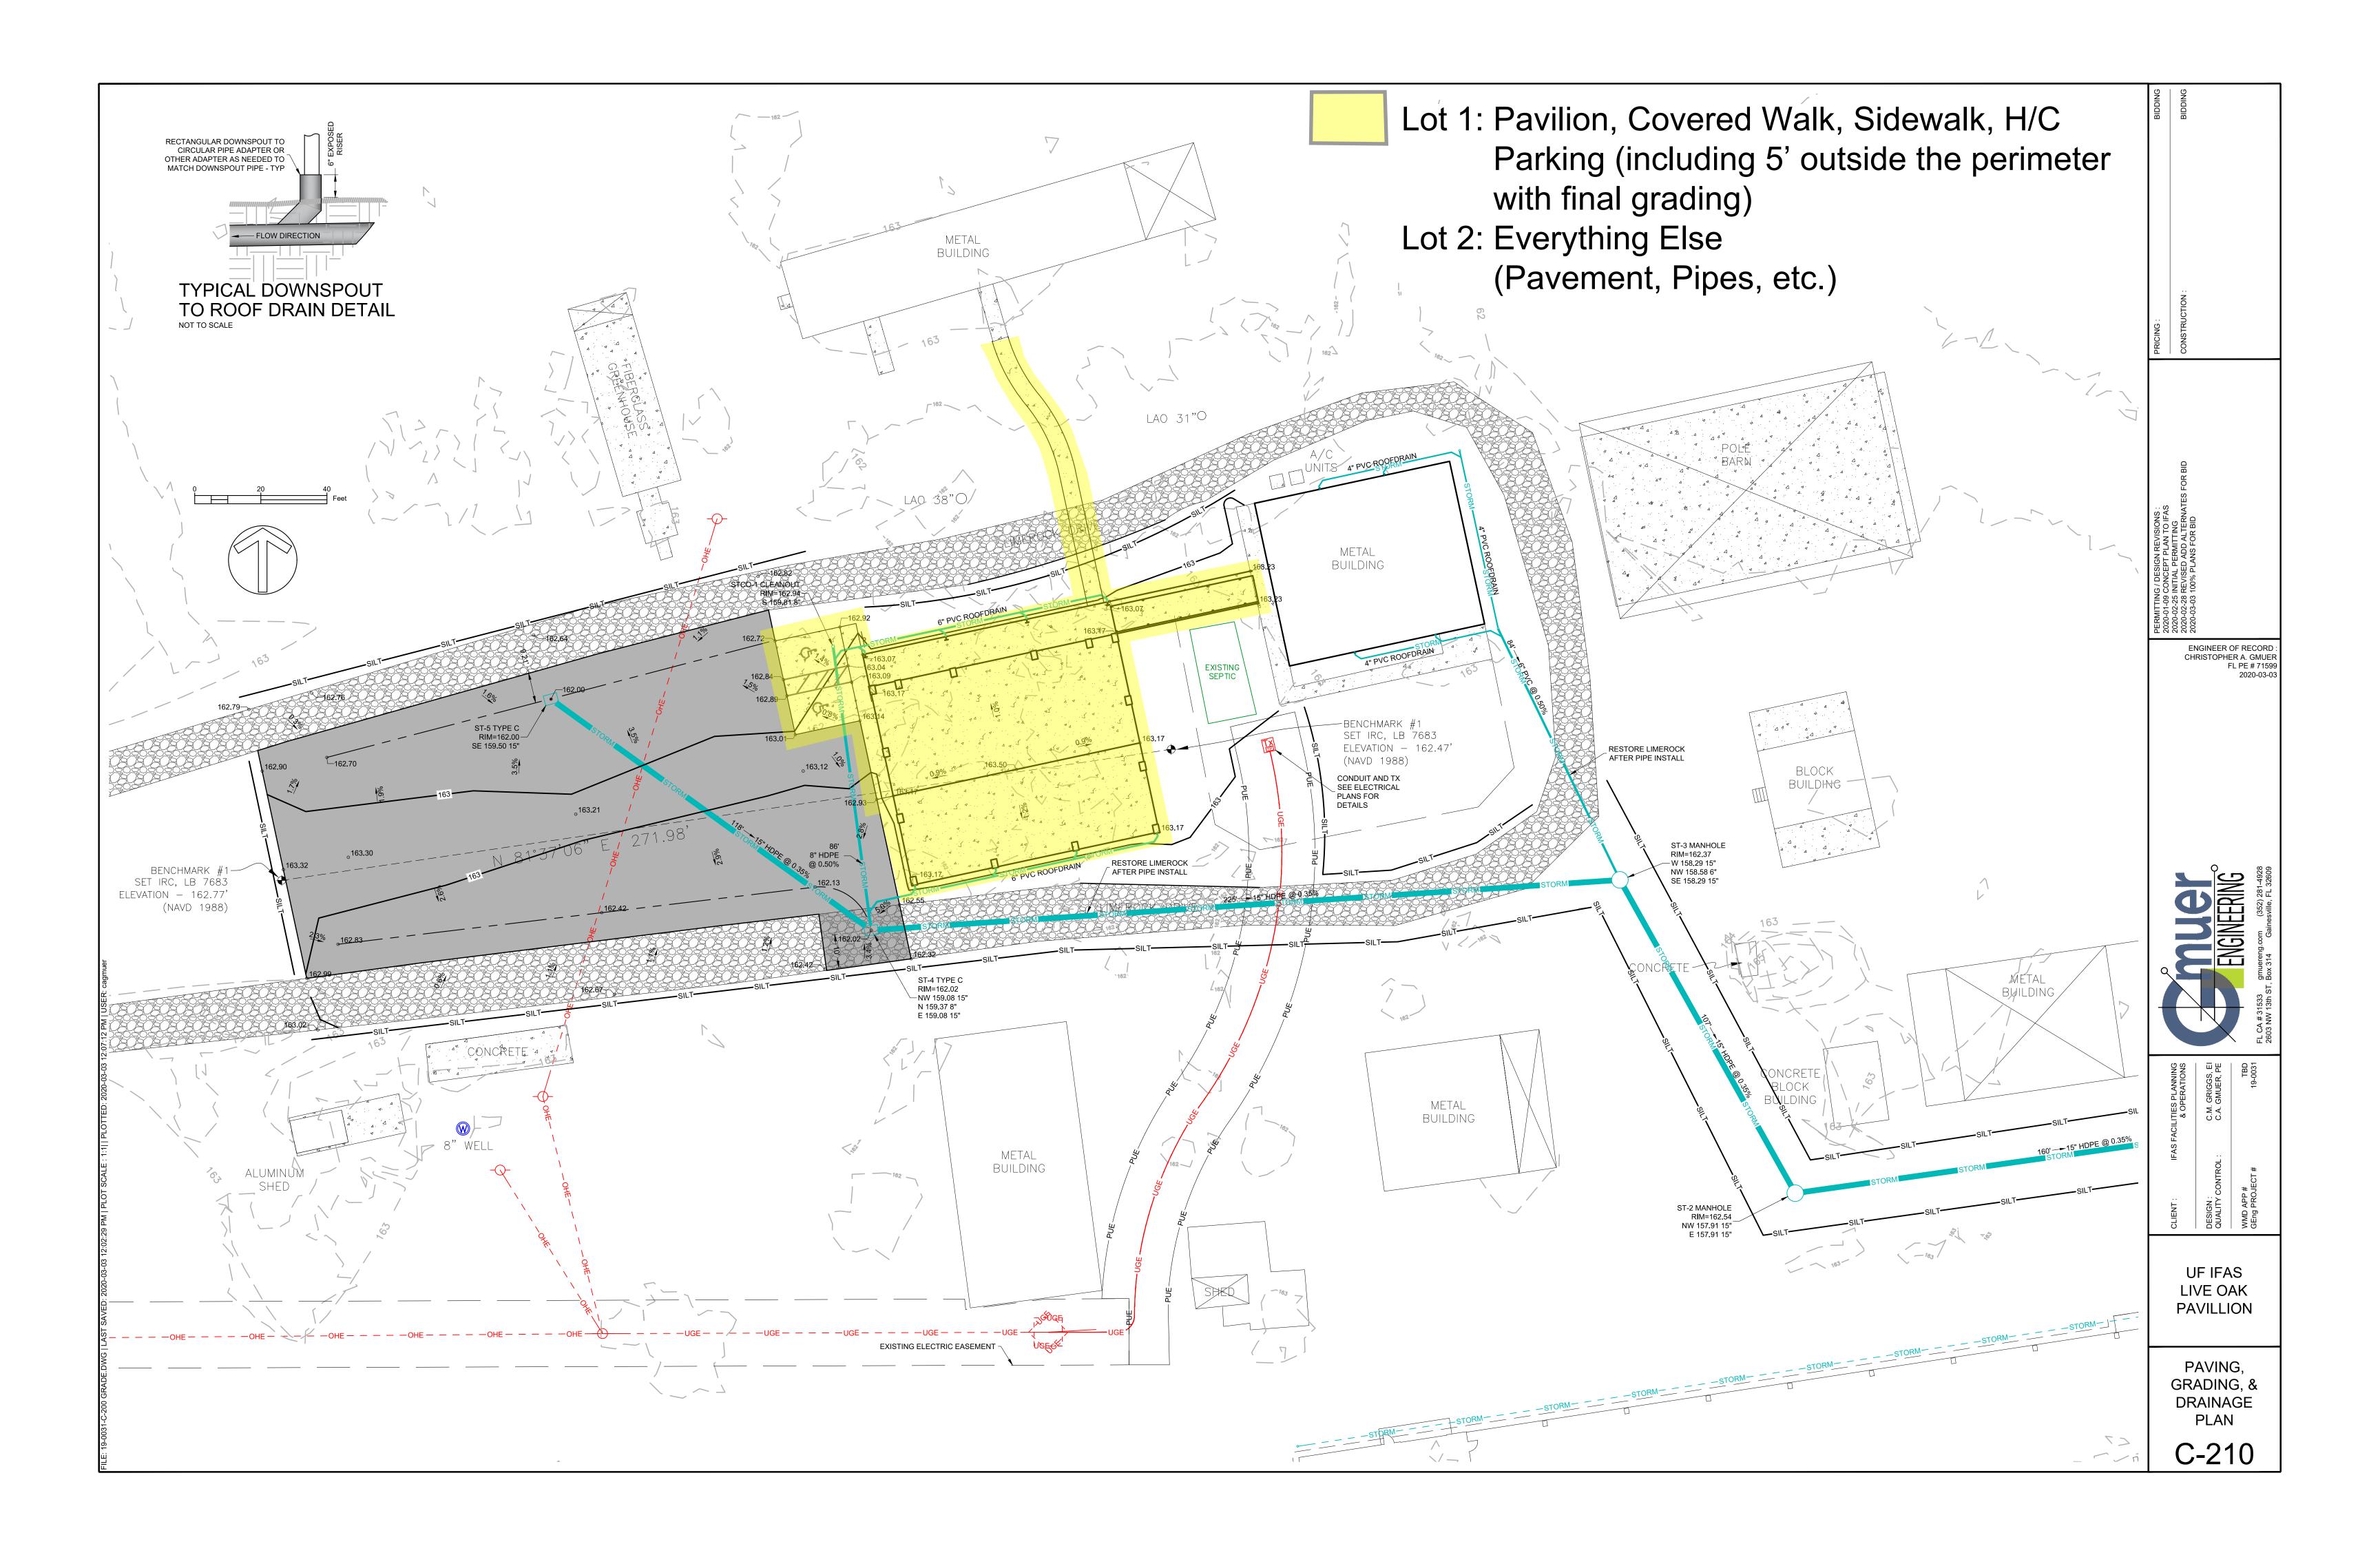

PROPOSED


UF/IFAS 20038 NORTH FLORIDA REC - LIVE OAK AGRICULTURE DEMONSTRATION BUILDING


UF PLANNING, DESIGN & CONSTRUCTION

LIVE OAK, FL

UF BLDG #8325

3D PLAN

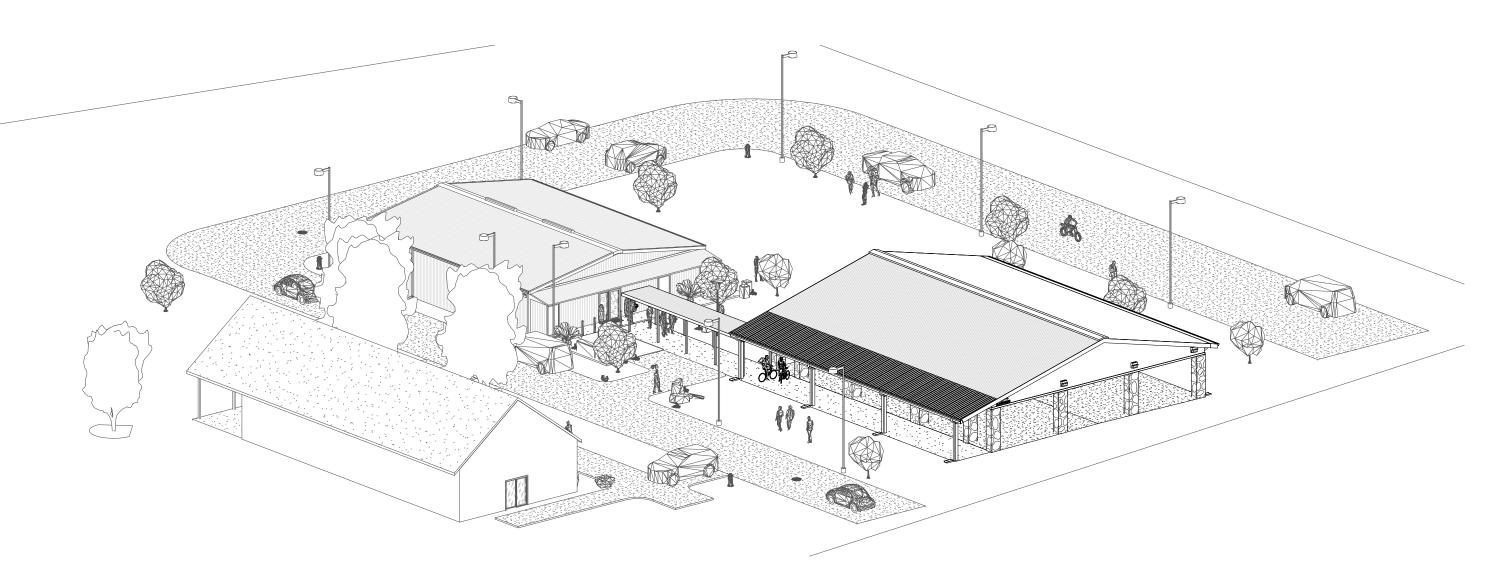

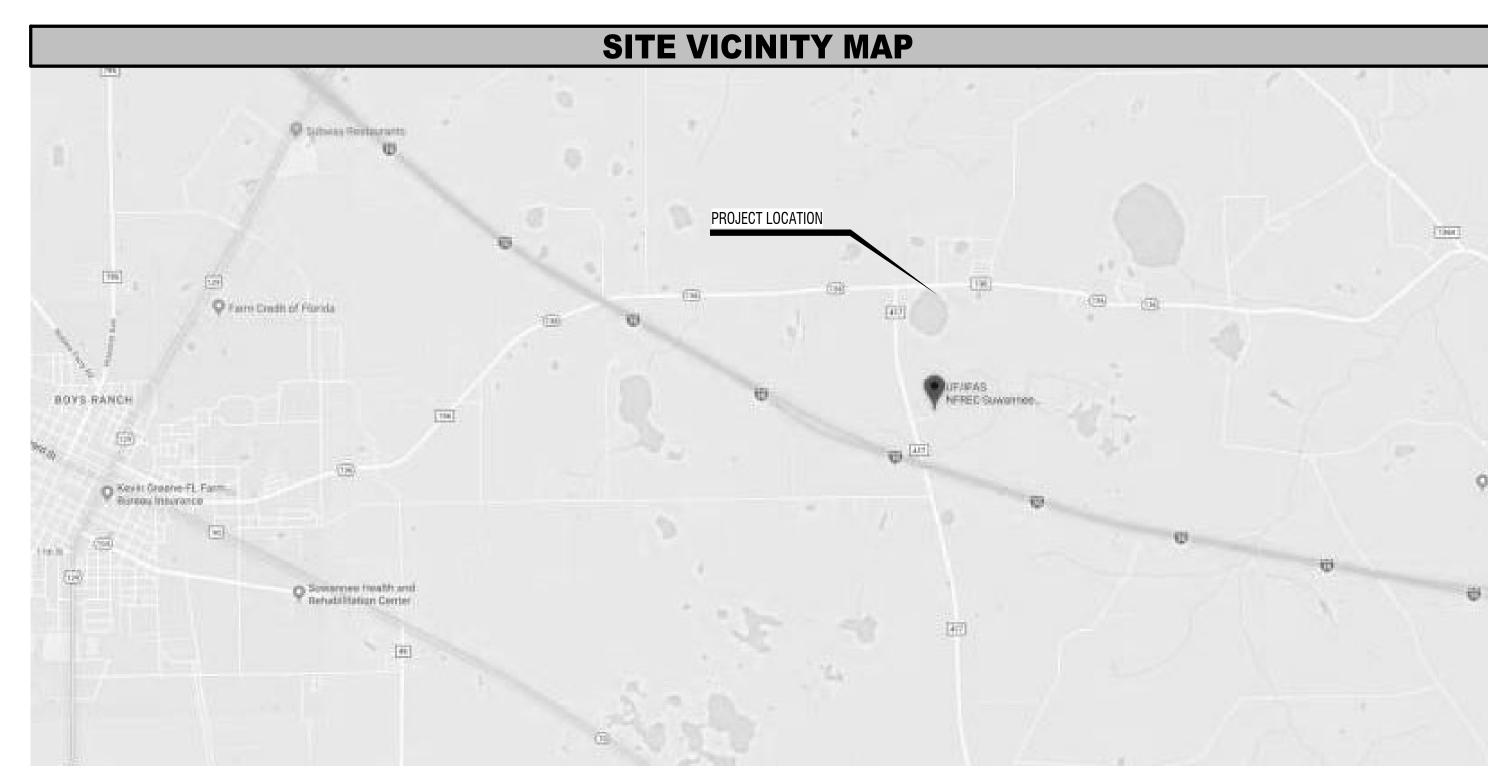

PROJECT INFORMATION

PROJECT NAME: UF/IFAS 20038 NORTH FLORIDA REC - LIVE OAK AGRICULTURE DEMONSTRATION BUILDING

PROJECT/ SITE ADDRESS

LIVE OAK, FL

OCCUPANCY TYPE - FBC: ASSEMBLY - GROUP A-3 OCCUPANCY TYPE - NFPA: ASSEMBLY NUMBER OF STORIES: 1 ABOVE GRADE NUMBER OF BUILDINGS: 1 AUTHORITIES HAVING JURISDICTION: UF EH&S OCCUPANT LOAD: 292

PROJECT SCOPE

DEMONSTRATION PAVILION:

GROUP A-3 ASSEMBLY OCCUPANCY. THE EAVES WILL BE 12' HIGH WITH SIDE PANELS DOWN TO 10' ON ALL FOUR SIDES. THE GALVALUME FINISH ROOF WILL HAVE A 3:12 PITCH WITH A 2' OVERHANG ON ALL 3 SIDES, AND A 10' WIDE SHED ROOF ON THE NORTH SIDE. GUTTERS ON THE NORTH AND SOUTH SIDES WILL BE ROUTED TO AN UNDERGROUND DRAINAGE SYSTEM VIA DOWNSPOUTS ON ALL &

THE SLAB WILL BE 4" THICK, DESIGNED FOR PEDESTRIAN USE, WITH A SMOOTI TROWEL FINISH, AND BE SLOPED TO DRAIN. COLUMN BASES WILL BE ELEVATED RELATIVE TO THE SLAB. FOUNDATION DESIGN WILL BE BASED UPON BUILDING MANUFACTURER-PROVIDED REACTIONS.

THE SIDE WALLS WILL BE R-PANELS WITH A 20-YEAR PAINTED FINISH OF OYSTER GREY WITH DARK GREEN TRIM

THE BUILDING WILL HAVE A 10' WIDE COVERED CONCRETE WALK ON THE NORTH SIDE. THE WALK WILL CONNECT THE BUILDING TO THE PARKING

NEW ELECTRICAL SERVICE, WITH POWER AND JUNCTION BOXES AT EACH COLUMN FOR THE ROLL-DOWN CURTAINS, POWER FOR THE CEILING FAN AND LIGHTING.

COVERED WALKWAY: PRE-ENGINEERED ALUMINUM CANOPY WITH LIGHTING OVER THE CONCRETE WALK CONNECTING THE MAIN ASSEMBLY BUILDING WITH THE PAVILION.

PLUMBING AND ELECTRICAL FOR AN ACCESSIBLE, HI-LOW WATER FOUNTAIN ON THE WEST EXTERIOR FACE OF THE MAIN ASSEMBLY BUILDING SITE WORK FOR ACCESSIBLE ROUTE TO ADJACENT RESTROOMS AND TO PARKING, PAVING AND DRAINAGE

#1: IN LIEU OF STANDARD METAL BUILDING COLUMNS, PROVIDE RECTANGULAR OR SQUARE COLUMNS ALONG THE NORTH SIDE OF THE COVERED WALK. #2: IN LIEU OF BARE GALVANIZED COLUMNS, WRAP THE BUILDING COLUMNS WITH FRAME AND STONE VENEER.

#3: IN LIEU OF OPEN BAYS, PROVIDE ROLL-DOWN, CLEAR WEATHER CURTAINS EQUIVALENT TO FENETEX

PLUMBING FIXTUERS:

ACCESSIBLE RESTROOM FIXTURES ARE ON SITE IN THE ADJACENT BUILDINGS 8239 & 8312. DURING DEMONSTRATION EVENTS, THEOCCUPANTS OF THESE BUILFING WILL BE AT THE DEMOSTRATION BUILDING.

ADDITIONAL ACCESSIBLE RESTROOMS WILL BE BROUGHT ON SITE FOR THE LARGER EVENTS THAT MAY OCCUR.

T INDEX	DRAWING SHEE						
Current Current Revision Date	SHEET # CIVIL PLANS SEE TOC ON C.000						
	COVER SHEET						
	FETY						
	PROPOSED - LIFE SAFETY - OVERALL						
'	ECTURAL PLANS						
	PROPOSED - PLAN - OVERALL						
	PROPOSED - ROOF PLAN						
	ECTURAL EXTERIOR ELEVATIONS						
A2.0 PROPOSED - ELEVATIONS - EXTERIOR							
A2.1 PROPOSED - ELEVATIONS - EXTERIOR							
	ECTURAL BUILDING SECTIONS						
	PROPOSED - SECTIONS - BUILDING						
	ECTUAL DETAILS						
	PROPOSED - DETAILS						
	NG						
IONS	PLUMBING LEGEND, NOTES & ABBREVIA-						
	PLUMBING FLOOR PLAN						
	ICAL						
	ELECTRICAL LEGEND, CODES &						
	ABBREVIATIONS						
E1.1 ELECTRICAL FLOOR PLAN - POWER							
E1.2 ELECTRICAL CEILING PLAN - LIGHTING							
	ELECTRICAL ROOF PLAN						
	TURAL						

CONSULTANTS

MEP ENGINEERS

MITCHELL GULLEDGE ENGINEERS CRAIG GULLEDGE 352-745-3991

CGULLEDGE (CGULLEDGE@MITCHELLGULLEDGE.COM)

210 SW 4th Avenue Gainesville, FL 32601

STRUCTURAL ENGINEER

WAYLAND STRUCTURAL ENGINEER (WSE) GREG WAYLAND 352-331-0727

WAYLANDGS@AOL.COM

2801 SW 81ST STREET GAINESVILLE, FL 32608

<u>CIVIL</u> <u>ENGINEER</u>

GMUER ENGINERRING (352)-281-4928

GMUERENG.COM

GENERAL NOTES

1. DRAWINGS ARE DIAGRAMATIC TO CONVEY EXISTING/NEW CONDITIONS CONTRACTOR SHALL INSPECT AND VERIFY THE SCOPE OF WORK. ANY

2. CONTRACTOR SHALL CHECK AND VERIFY ALL DIMENSIONS AND NOTIF' ARCHITECT IMMEDIATELY OF ANY DISCREPANCIES

3. NO INSTRUCTION, REVISIONS, ADDITIONS, DELETIONS, SPECIFICATIONS OR DOCUMENTS AND COMPLY WITH ALL PROVISIONS THEREIN. IF THERE IS A DESCREPANCY BETWEEN CONTRACT DOCUMENTS, EXISTING CONDITIONS AND VENDOR SUPPLIED WATER TREATMENT DOCUMENTS. GC TO VERIFY AND COORDINATE PRIOR TO INSTALLATION OF ANY SLEAVING.

5. ALL MATERIALS SHALL BE INSTALLED IN ACCORDANCE W/ MANUFACTURER'S INSTRUCTIONS. IT IS GENERAL CONTRACTOR'S RESPONSIBILITY TO VERIFY AND APPROVE ALL DIMENSIONS OF EQUIPMENT AND MATERIAL WITH SUPPLIERS PRIOR TO ORDERING AND / OR INSTALLATION OF ALL PRODUCTS. 6. RFI'S - SUBMIT ALL QUESTIONS ON RFI DOCUMENT PROVIDED IN BID DOCUMENTS WITH DATE OF REQUEST. ARCHITECT WILL PROVIDE RESPONSE AS

QUICKLY AS PRACTICAL.

7. UPON GENERAL CONTRACTOR APPROVAL, ALL SUBMITTALS ARE TO BE SENT FROM THE SUBCONTRACTOR TO THE GENERAL CONTRACTOR FOR REVIEW AND SUBMISSION TO THE ARCHITECT; THE SUBCONTRACTOR IS TO FLAG ANY SUBSTITUTIONS. THE FULL SUBMITTAL PACKAGE IS TO BE SENT ELECTRONICALLY IN PDF FORMAT ON EITHER CD, FTP WEBSITE FOR DOWNLOAD, OR DROP BOX TO THE ARCHITECT WITHIN TWO WEEKS OF AWARD. ALL SUBMITTALS ARE TO BE REVIEWED BY GC PRIOR TO SUBMISSION TO THE ARCHITECT. ALL NON-REVIEWED SUBMITTALS WILL BE REJECTED. THE ARCHITECT WILL SUBMIT TO THE PROJECT MANAGER COPIES OF ALL REJECTED SUBMITTALS AND APPROVED SUBSTITUTIONS. ALL APPROVED SUBMITTALS AND CUT-SHEETS ARE TO BE MADE AVAILABLE PERMANENTLY ON THE JOB SITE FOR FUTURE REFERENCE DURING CONSTRUCTION MEETINGS. TIMELINESS OF SUBMITTALS IS OF EXTREME IMPORTANCE DUE TO PROJECT SCHEDULE. LATE SUBMITTALS WILL BE BACKCHARGED FROM THE SCHEDULE OF VALUES.ANY REVIEWS AFTER THIRD WEEK SHALL BE BORNE BY GENERAL CONTRACTOR @ A RATE OF \$200 PER SUBMITTAL.

8. PROJECT MAY INCLUDE MISCELLANIOUS STANDARD DETAILS. GC IS TO REVIEW ALL TO VERIFY ALL ARE APPLICABLE. SOME DETAILS MAY BE MIRRORED FOR THIS PROJECT COORDINATE W/ FLOOR PLAN.


9. SEE PROJECT MANUAL SECTION 01100 FOR ALTERNATES (WHEN APPLICABLE). 10. SEE PROJECT MANUAL SECTION 01021 FOR ALLOWANCES (WHEN

11. SEE LS SERIES DRAWINGS FOR CODE DATA & LIFE SAFETY INFORMATION. 12. SEE SHEET AO.O.1 FOR ALL REQUIRED ADA & FIXTURE HEIGHTS. 13. IT IS THE RESPONSIBILITY OF THE GENERAL CONTRACTOR AND ALL SUBCONTRACTORS TO VISIT THE JOBSITE AND FAMILIARIZE THEMSELVES WITH ALL EXISTING CONDITIONS IN THE FIELD. ANY DISCREPANCIES BETWEEN EXISTING FIELD CONDITIONS AND THE CONSTRUCTION DOCUMENTS ARE TO BE BROUGHT TO ARCHITECT'S ATTENTION IMMEDIATELY PRIOR TO BIDS BEING DUE. OWNER WILL PROVIDE DIRECTION TO GENERAL CONTRACTOR FOR BIDDING PURPOSES TO ASSURE APPROPRIATE SCOPE IS INCLUDED WITHIN BID. 14. CONTRACTOR IS TO COORDINATE WITH TENANTS, LANDLORDS AND/OR SURROUNDING TENANTS/LANDOWNERS WHEN PERFORMING ANY WORK. THERE SHALL NOT BE ANY DISRUPTION OF SERVICES FOR THE SURROUNDING TENANTS/LANDOWNERS DURING THE CONSTRUCTION / RELOCATION AND/OR

EXPANSION AND/OR RENOVATION OF THE FACILITY.

McLEAN, INC VIGNOLA

SKINNER

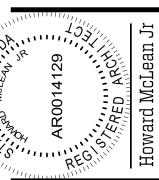

DATE: **03/12/2020**

COVER SHEET

* ALL SYMBOLS SHOWN MAY NOT BE ON PLAN

FIRE ALARM, EXTINGUISHERS, EXITS

1. FOR EXIT SIGNS AND EMERGENCY LIGHTS, SEE ELECTRICAL PLAN

used.

GENERAL NOTES - LIFE SAFETY - OVERALL

Egress from building will be possible from all sides when the weather curtains are not lowered. The two Exits shown on the north side will remain open for accessible egress at all times. See Electrical for emergency and exit lighting Use of building will include demonstrations of agricultural equipment and techniques, with exhibition booths similar to those in trade fairs. Table and chair arrangements may also be

OCCUPANT LOAD BREAKDOWN

292 (1 PERSON / 15 SF) A - ASSEMBLY = (1 PERSON / 100 SF) B - BUSINESS = S - ACC/SUPPLY = (1 PERSON / 300 SF)

TOTAL OCCUPANCY LOAD = 292

LONGEST PATH TO EXIT:

LONGEST RUN = 69 FEET

T1017.2: EXIT ACCESS TRAVEL DISTANCE - 200' W/O SPRINKLER SYSTEM (MOST RESTRICTIVE).


TOTAL AREA BREAKDOWN

INTERIOR WALLS = EXTERIOR WALLS = INTERIOR ROOMS = EXTERIOR ROOMS = BELOW ROOF ROOMS =


GFA (NFPA) =

AREA LEASABLE (BOMA) =

4,366 AREA BUILDING (IBC)=

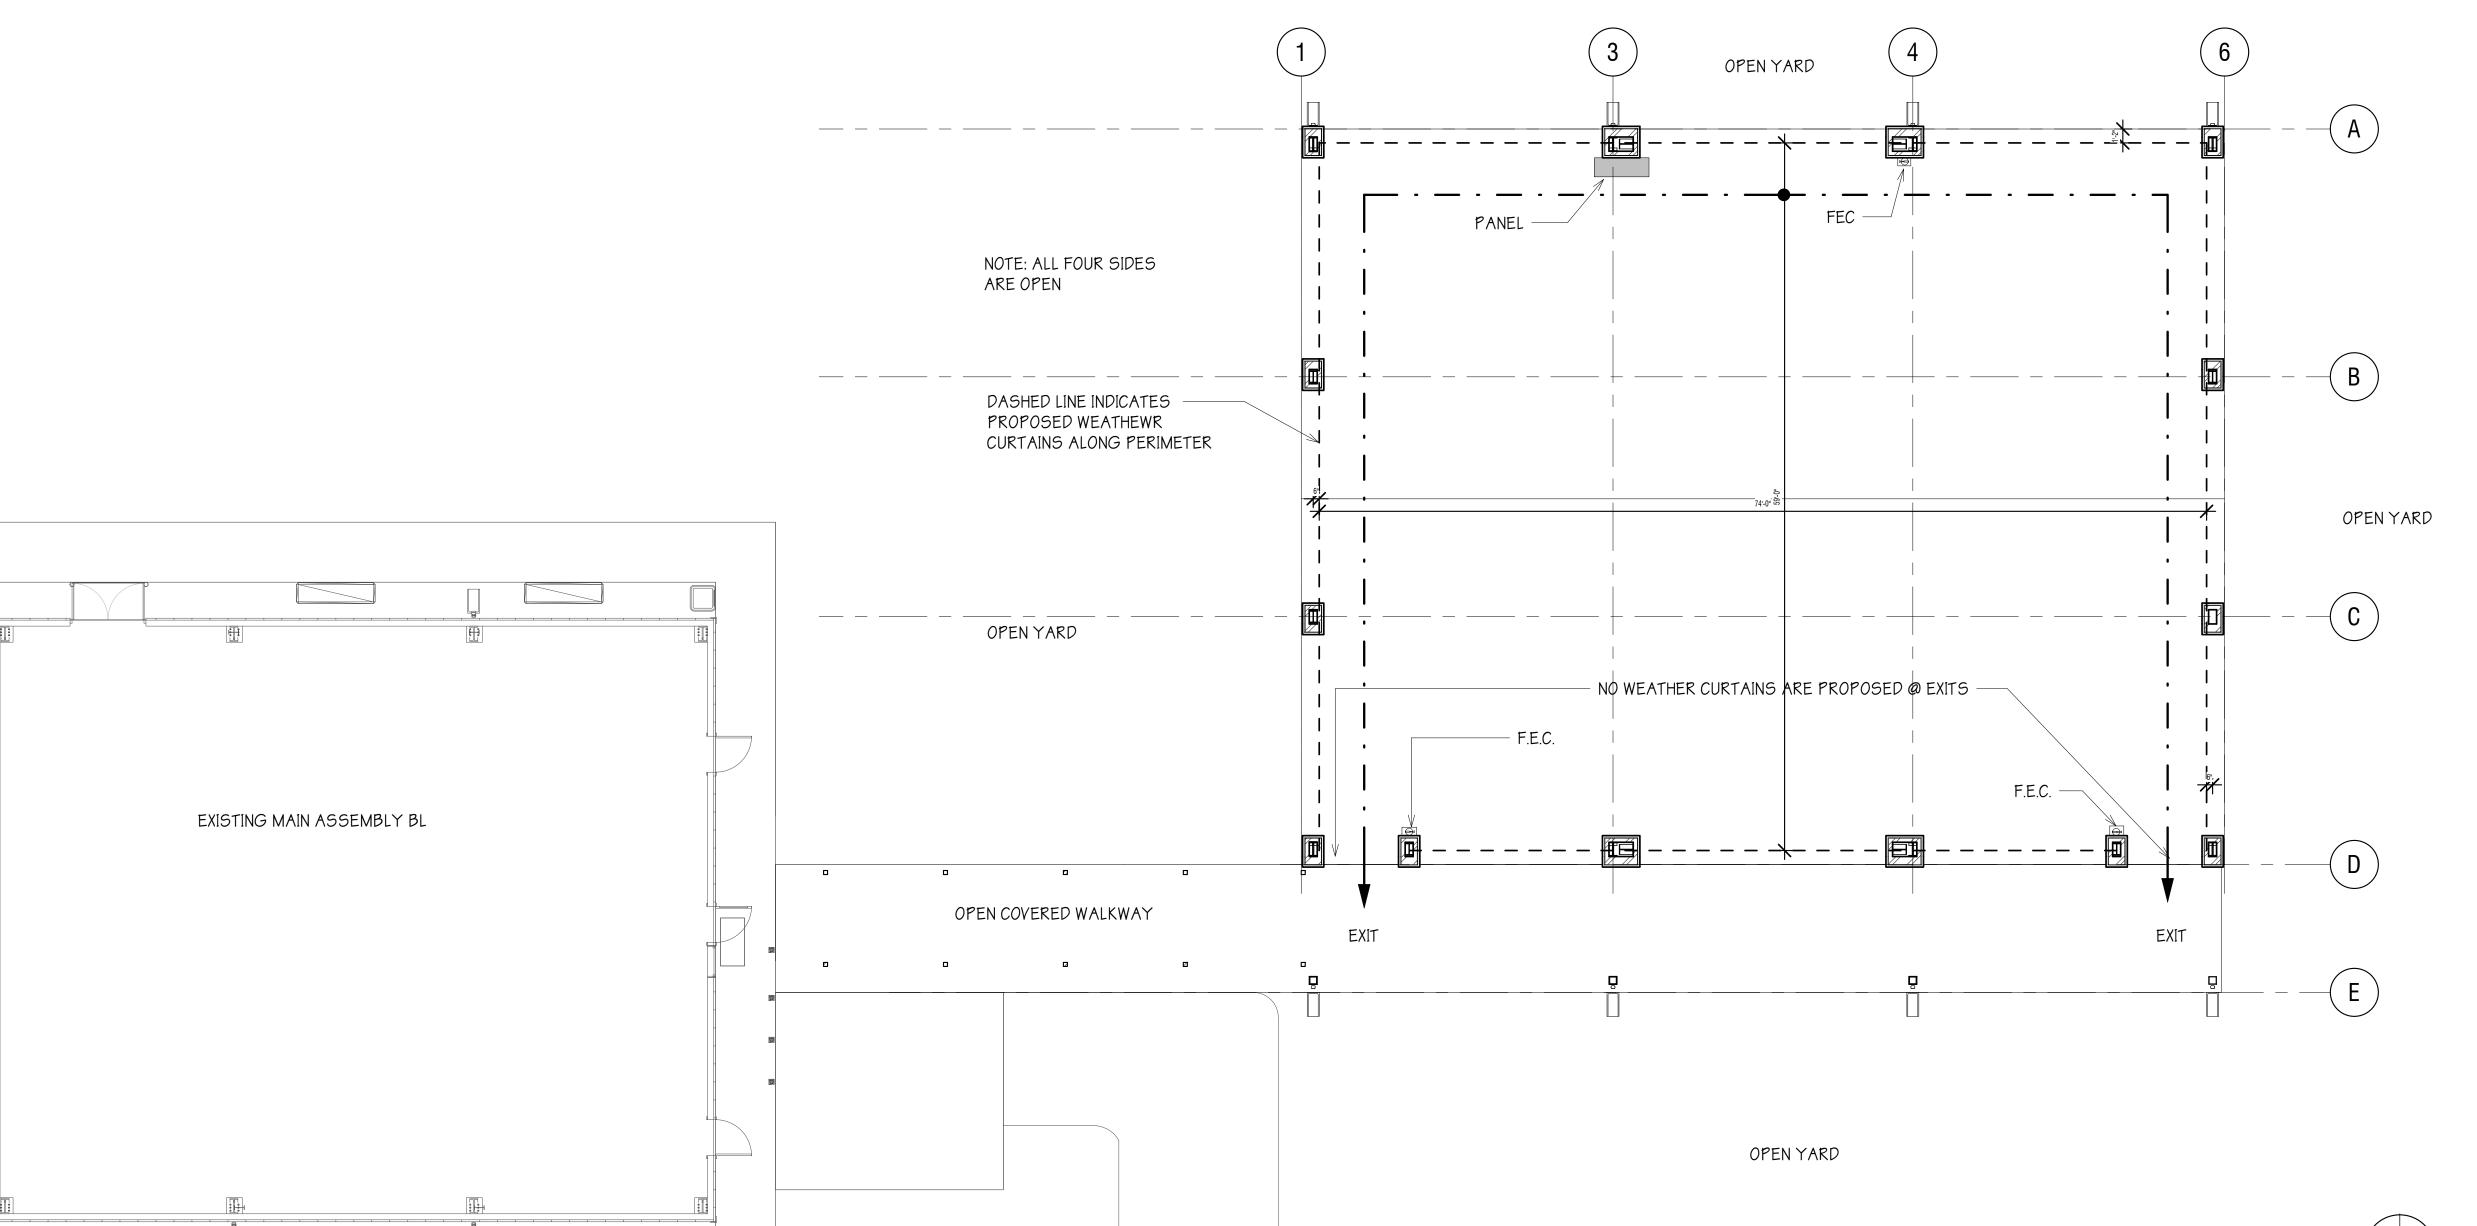

PROPOSED - LIFESAFETY - OVERALL LS1.0 SCALE: 1/8" = 1'-0"

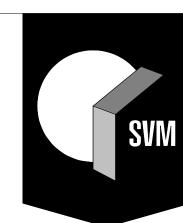

SKINNER VIGNOLA MCLEAN, INC.

ARCHITECTS & PLANNERS | FL CERTIFICATE | AA3478 **SVM**





PLANNING, DESIGN CONSTRUCTION

DATE: **03/12/2020**

PROPOSED - LIFE SAFETY -

OVERALL 1460-30

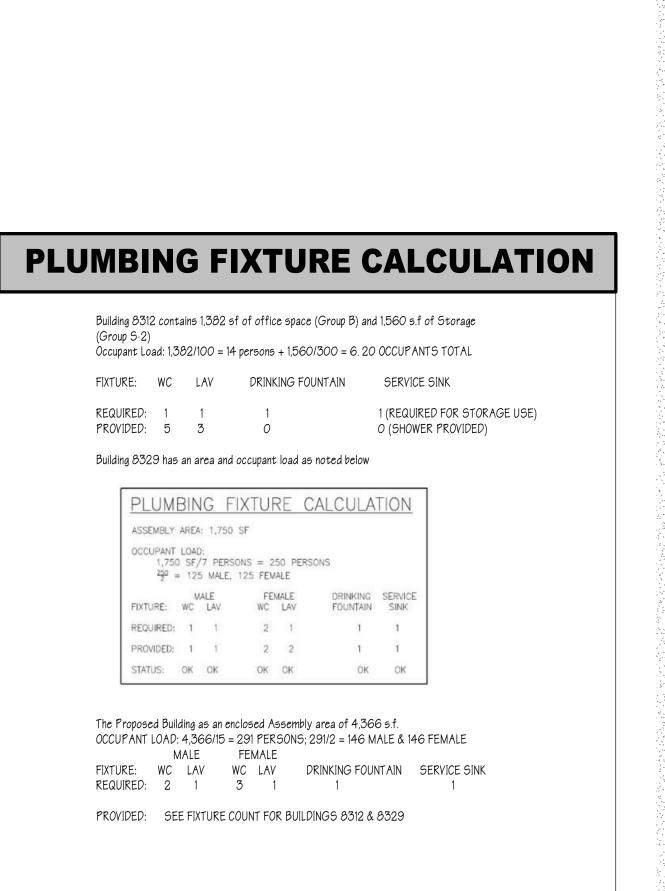

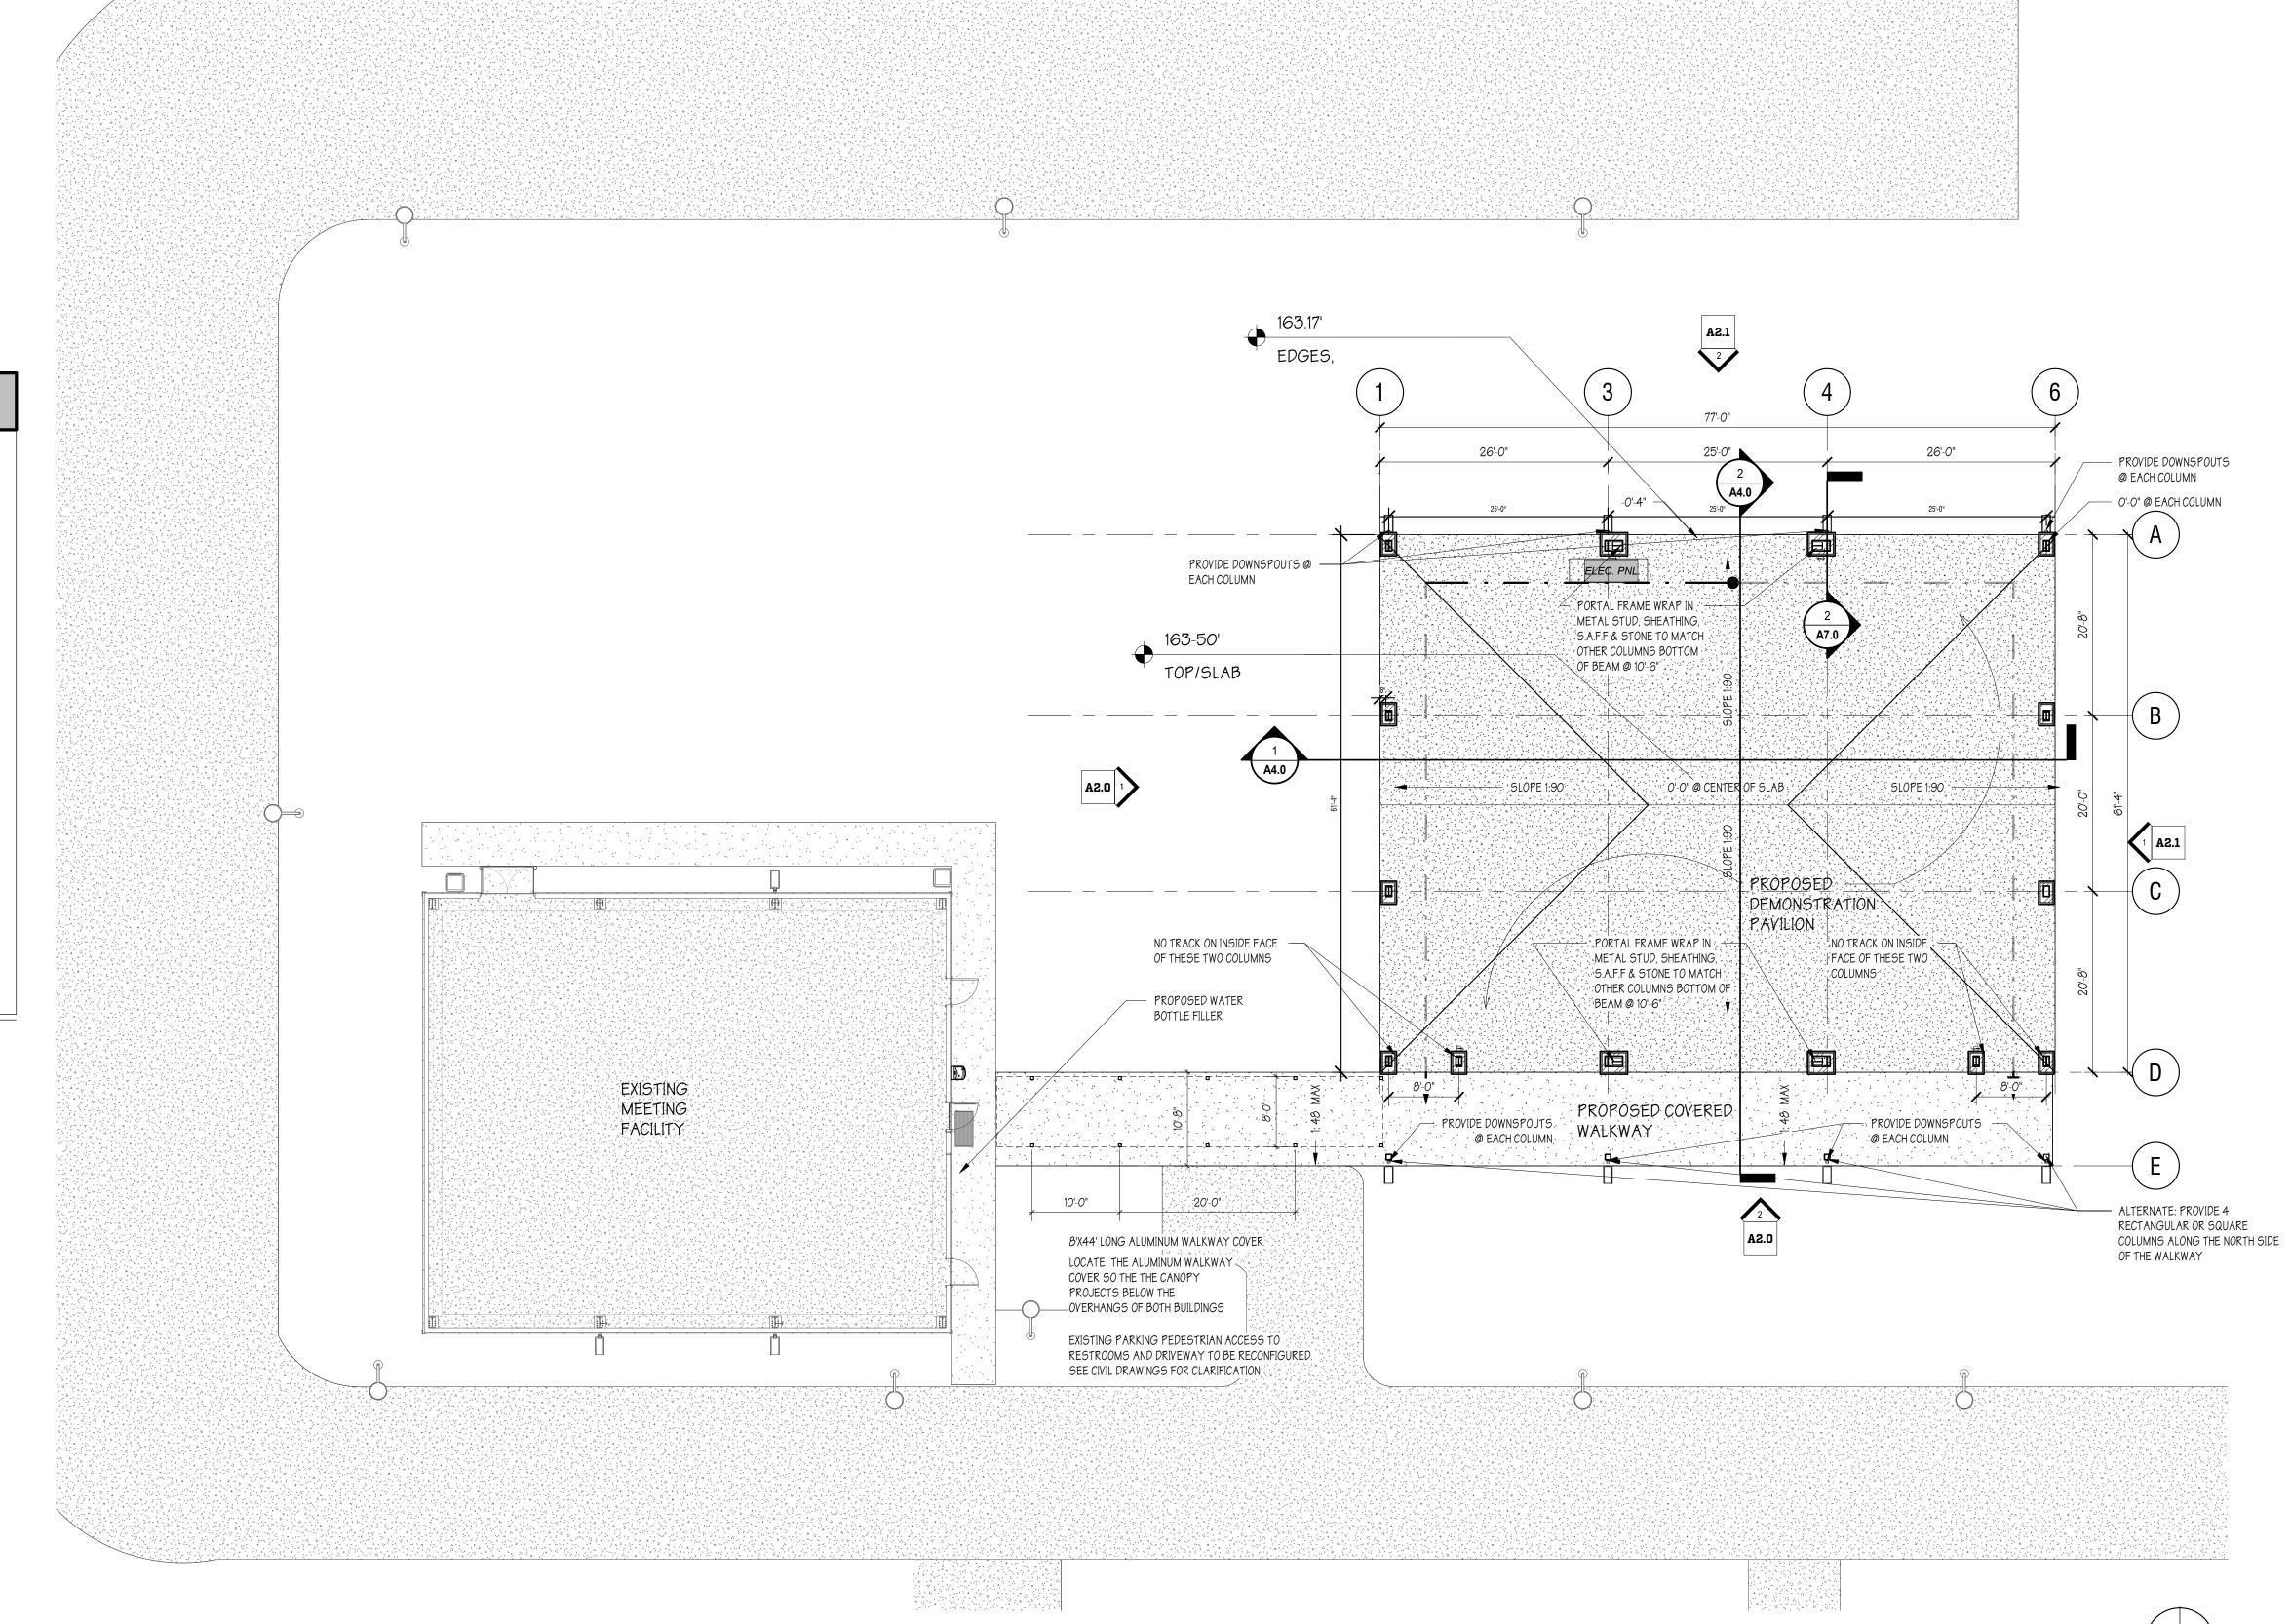




SKINNER VIGNOLA MCLEAN, INC.


SVM

PLANNING, DESIGN CONSTRUCTION

DATE: 03/12/2020
DRAWN BY: JER
CHECKED BY: HJM

PROPOSED - PLAN - OVERALL

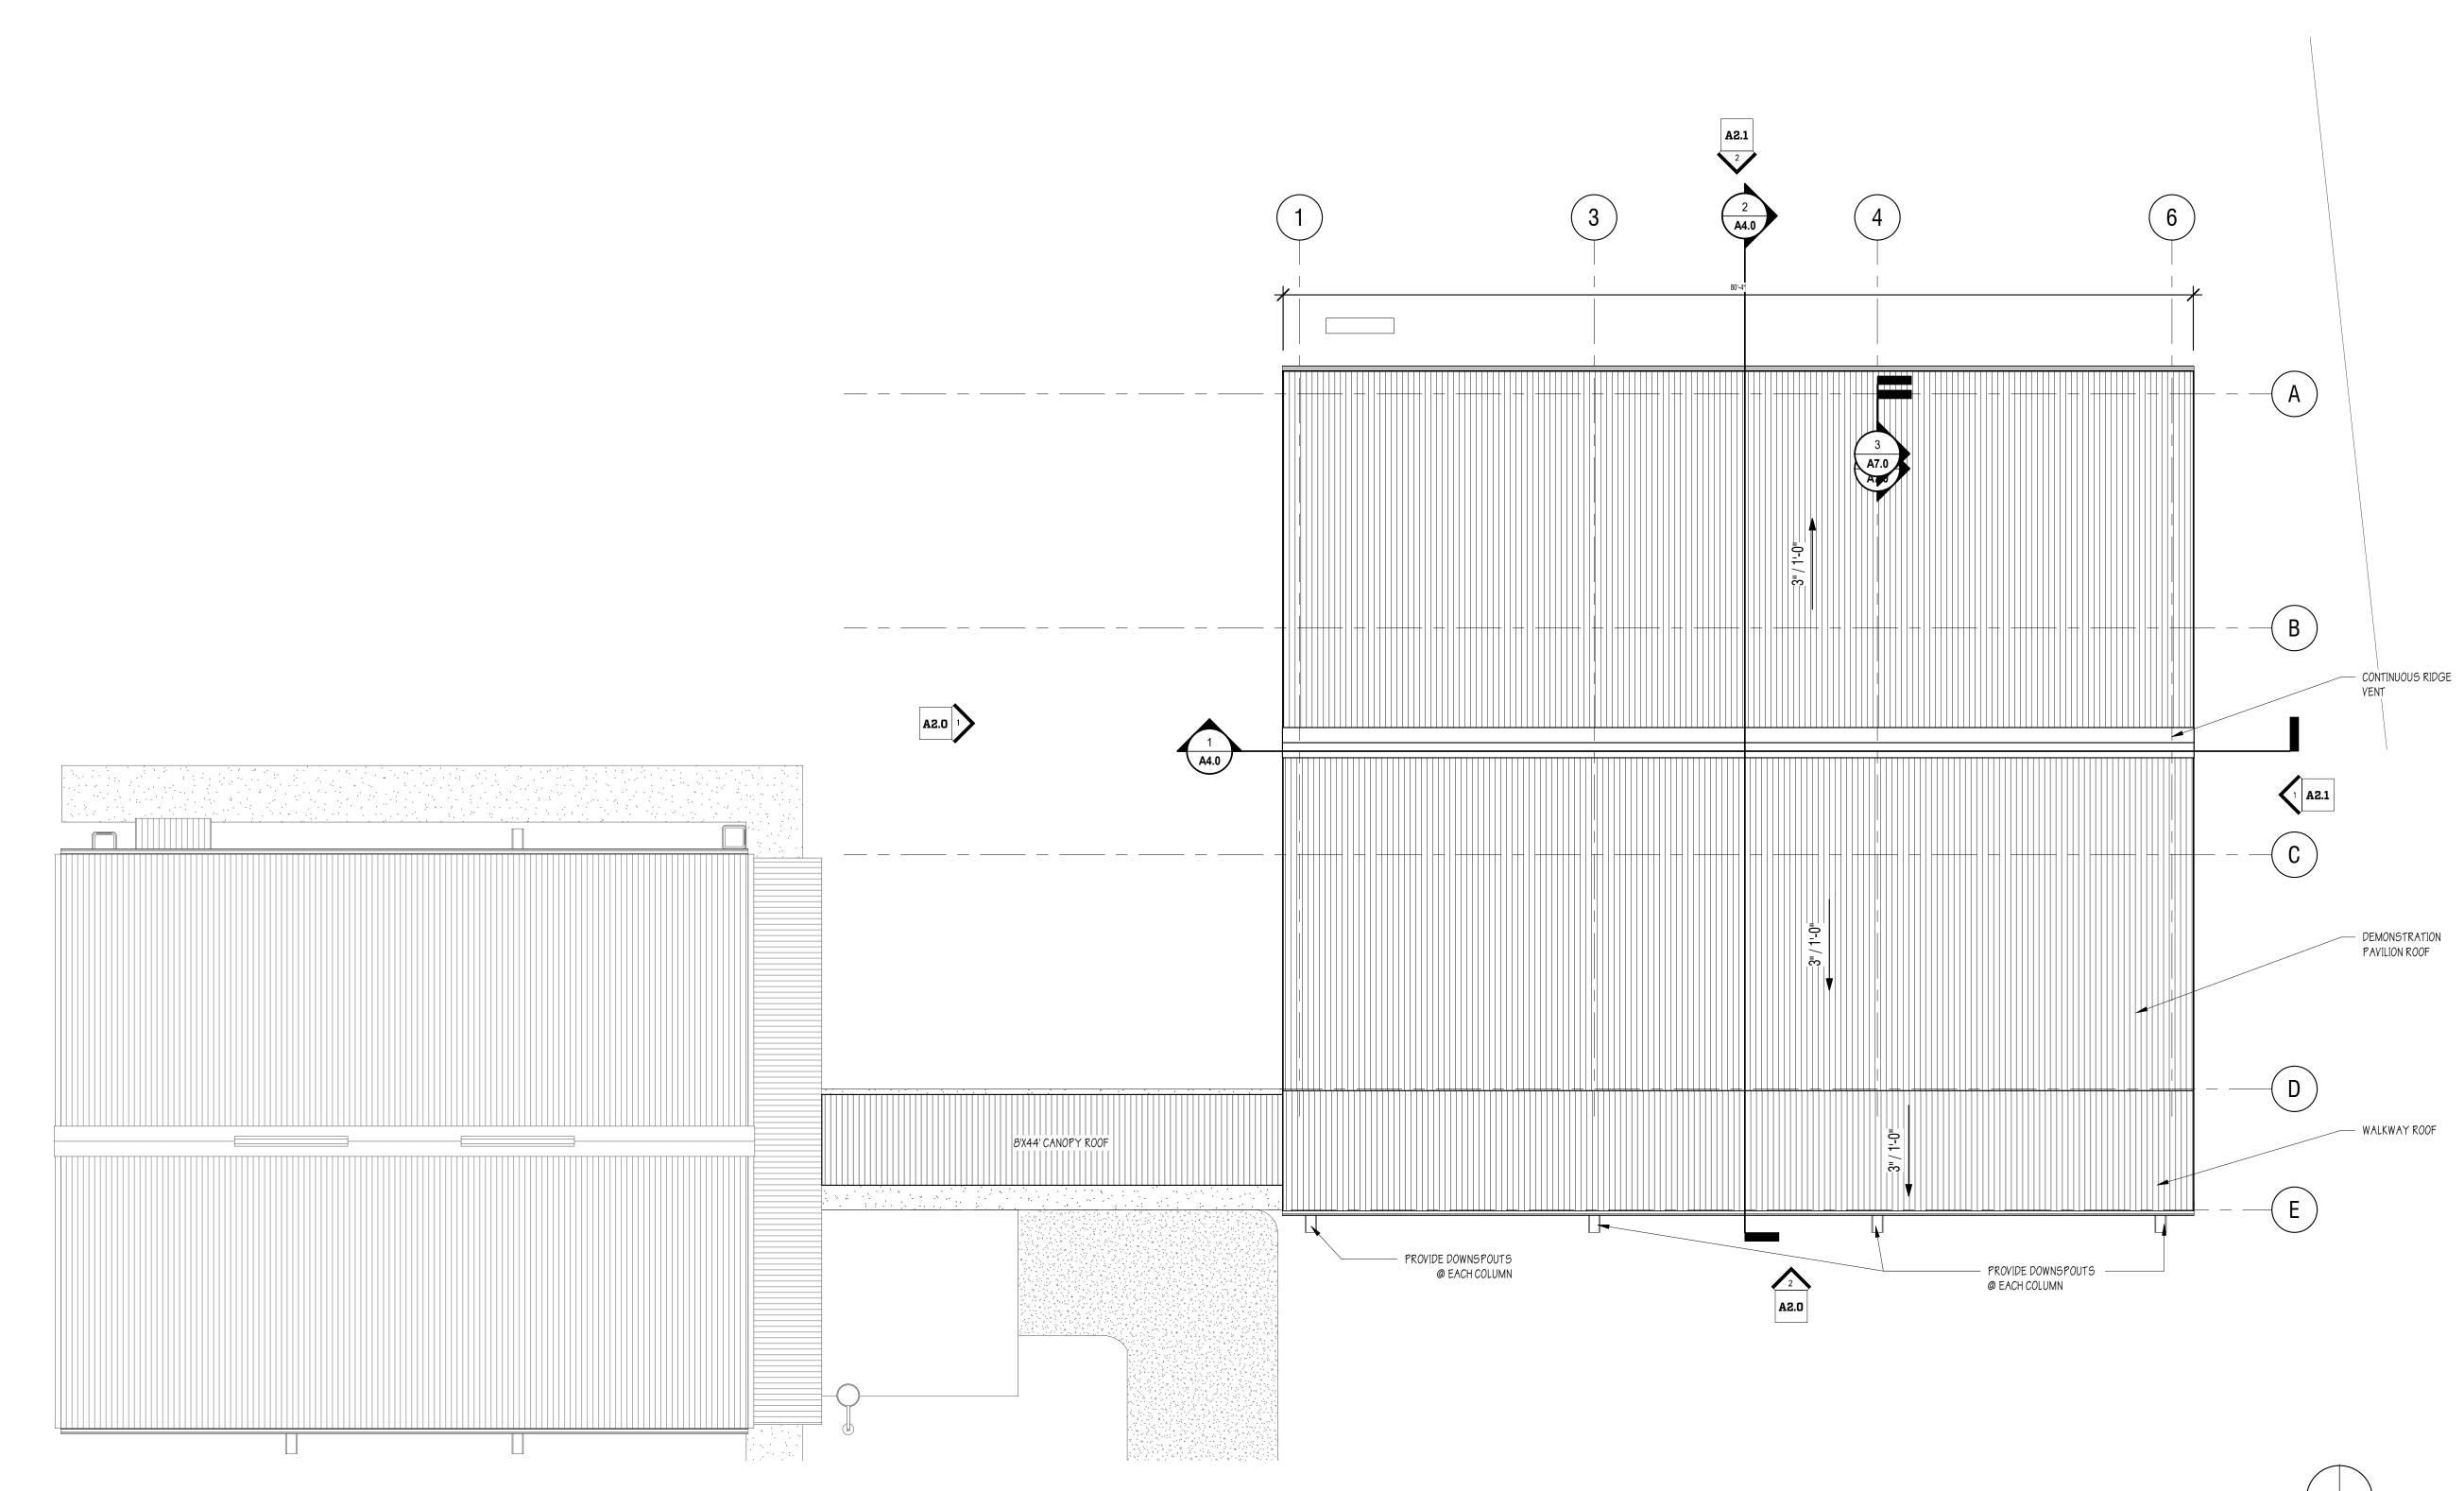

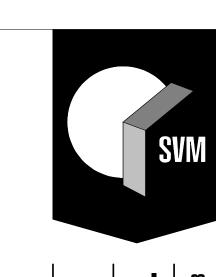

SKINNER VIGNOLA MCLEAN, INC.
ARCHITECTS & PLANNERS | FL CERTIFICATE | AA3478 **SVM** | P.352.378.4400 | F.352.377.5378


F PLANNING, DESIGN 6 CONSTRUCTION


DATE: 03/12/2020
DRAWN BY: JER
CHECKED BY: HJM


PROPOSED - ROOF PLAN

1460-30


PROPOSED - PLAN - ROOF
SCALE: 1/8" = 1'-0"

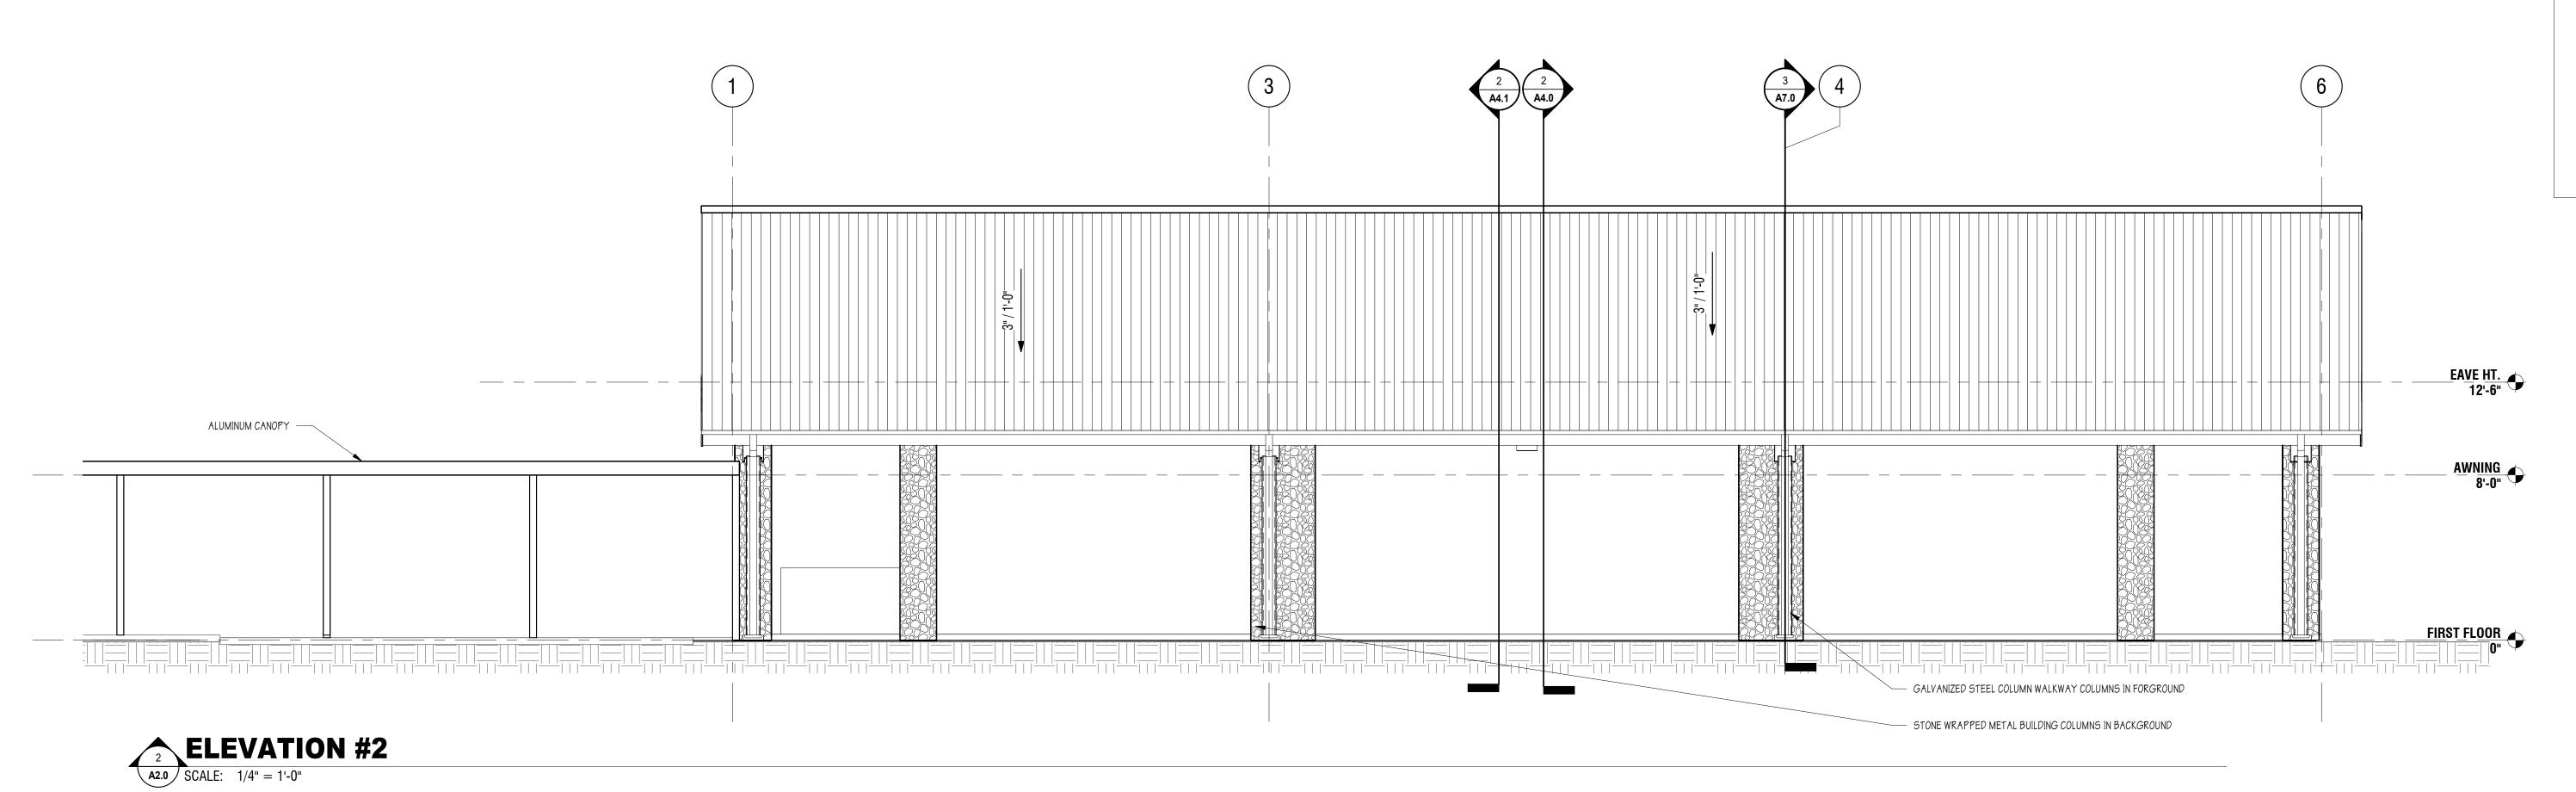

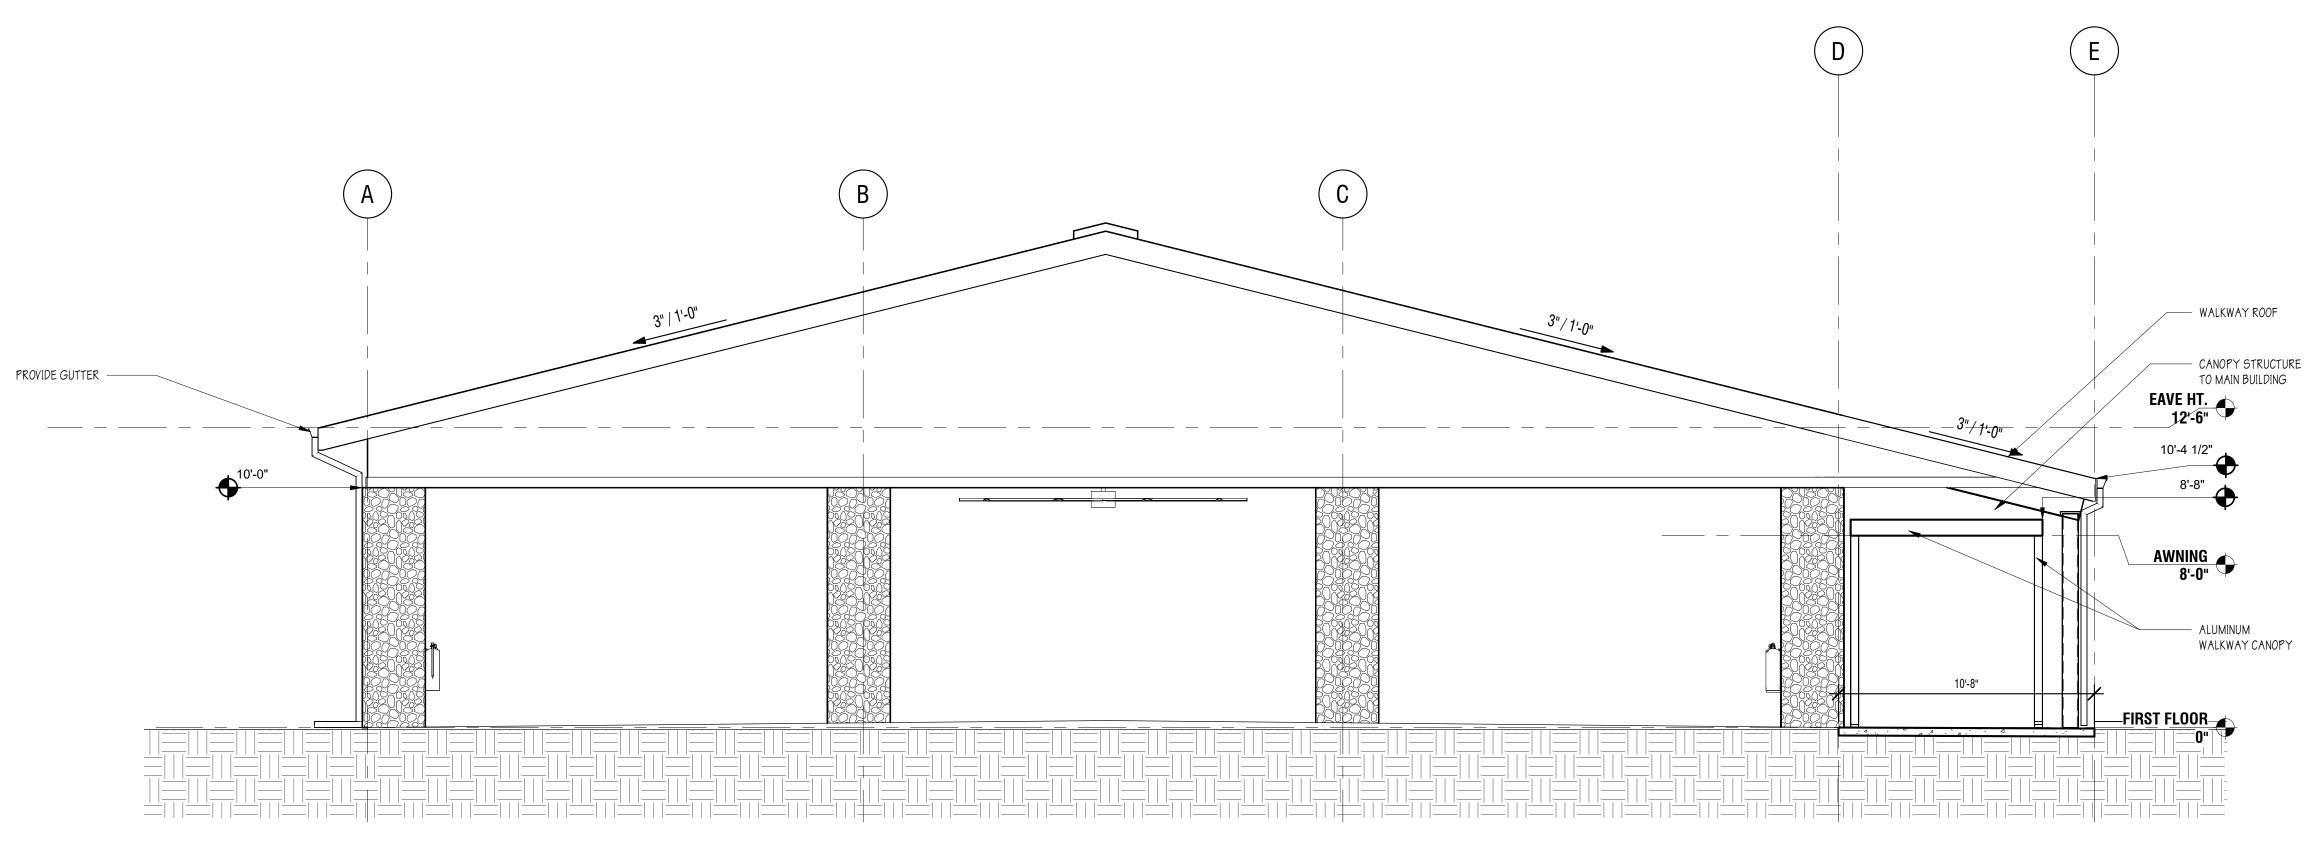


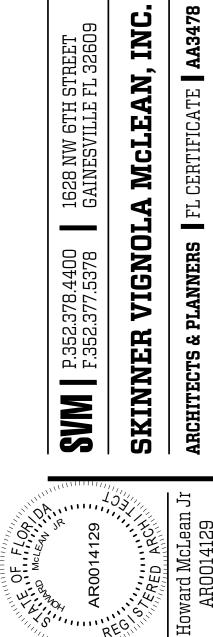

1628 NW 6TH STREET GAINESVILLE FL 32609

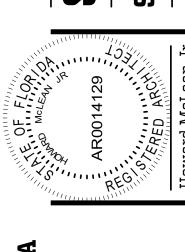



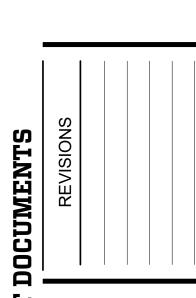



DATE: 03/12/2020
DRAWN BY: JER
CHECKED BY: HJM


PROPOSED -ELEVATIONS -

EXTERIOR 1460-30

1 ELEVATION #1 A2.0 SCALE: 1/4" = 1'-0"

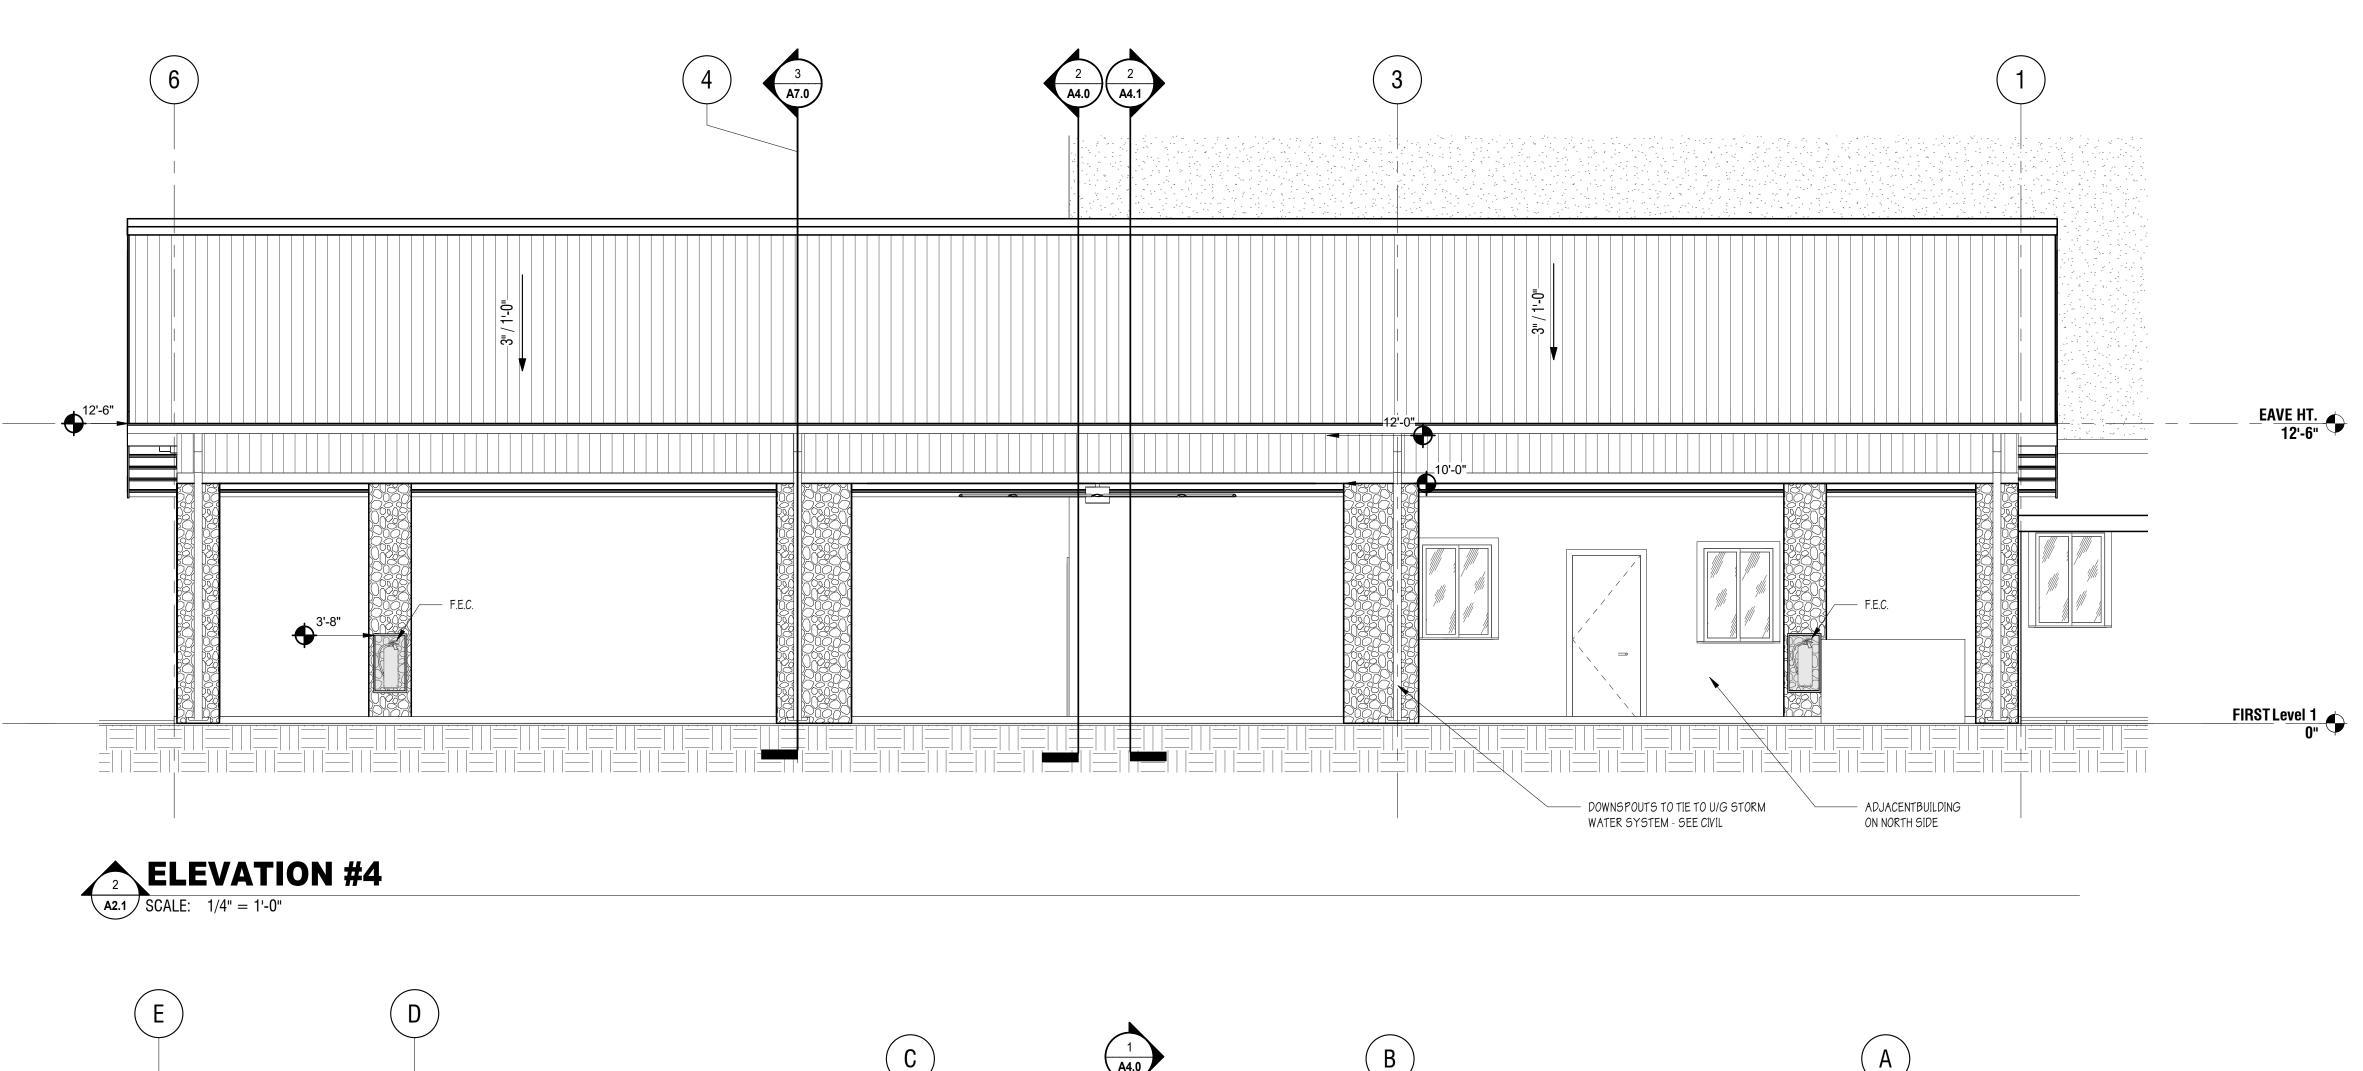


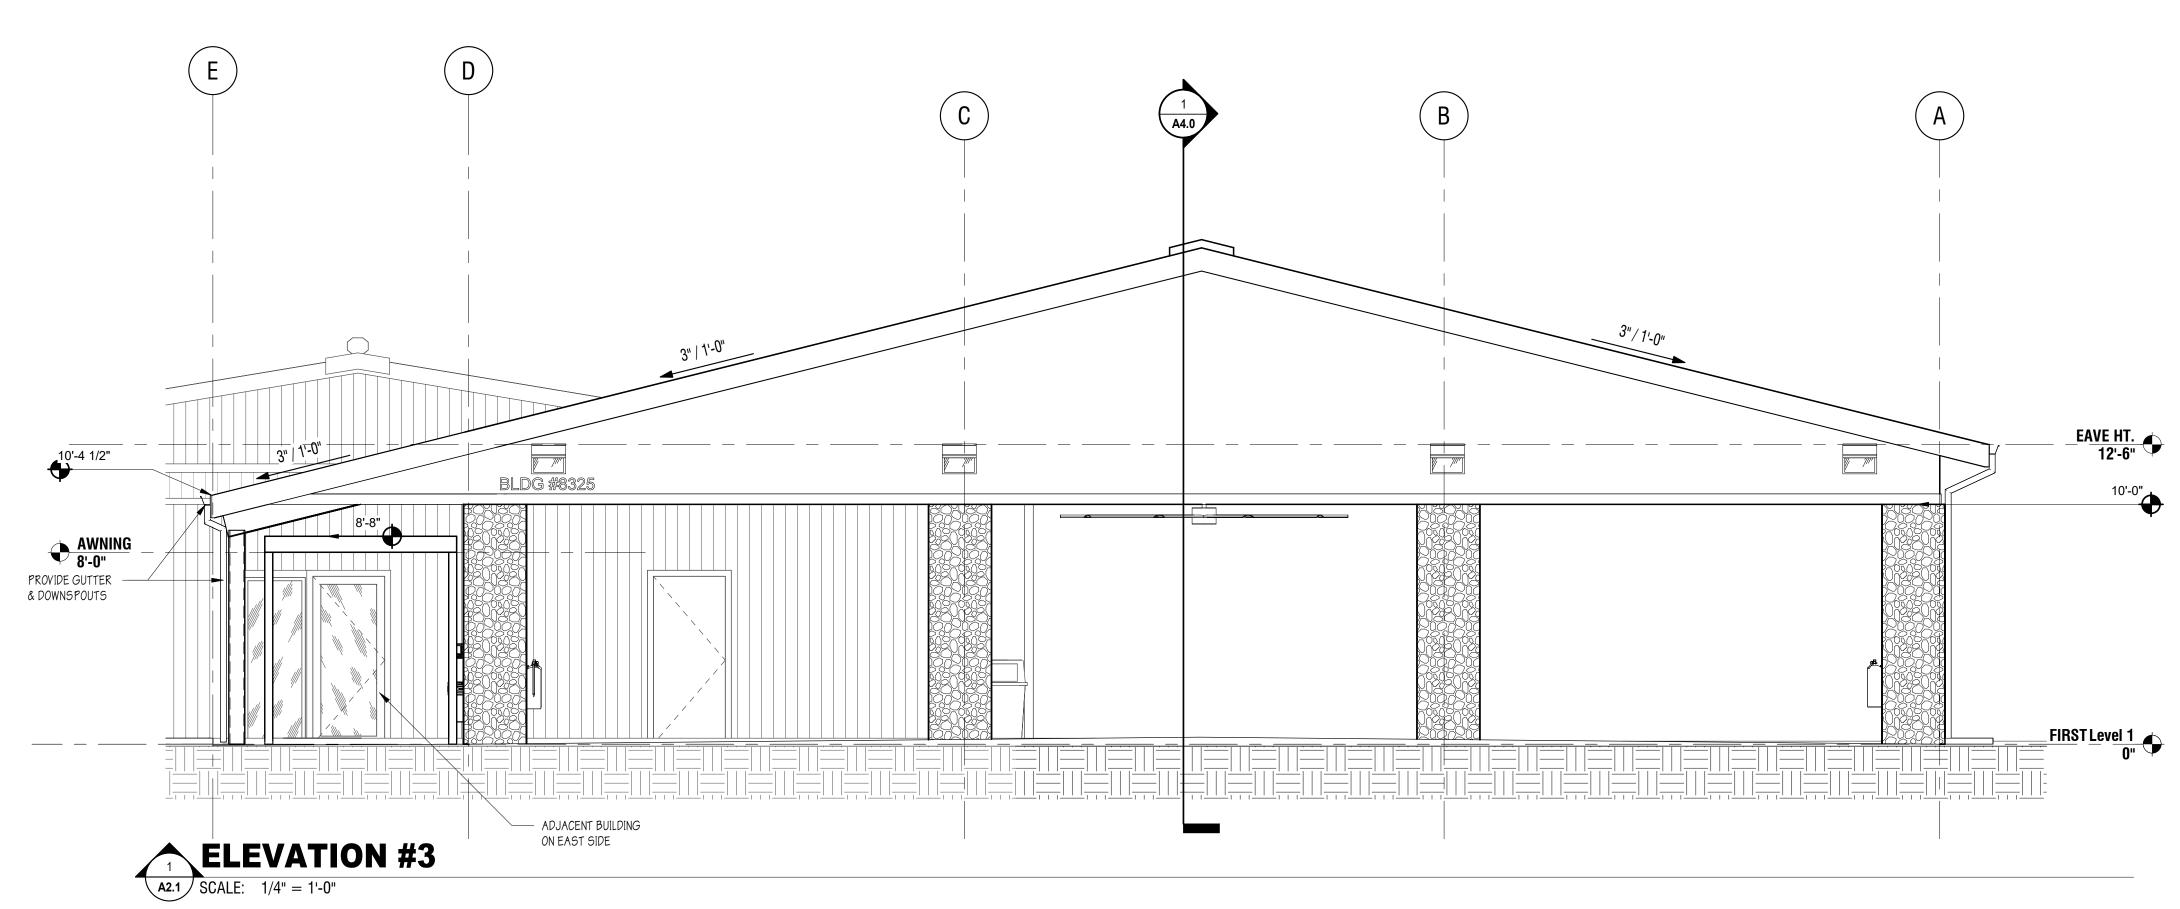

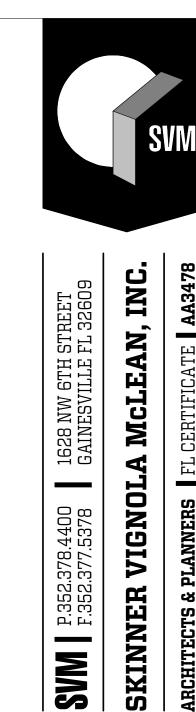


1628 NW 6TH STREET GAINESVILLE FL 32609

SVM | P.352.378.4400 F.352.377.5378

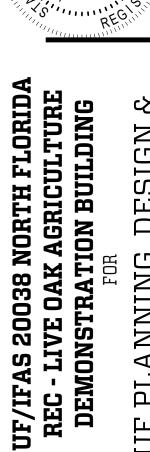



F PLANNING, DESIGN 6 CONSTRUCTION

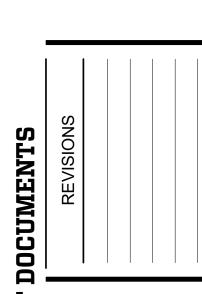

DATE: 03/12/2020
DRAWN BY: JER
CHECKED BY: HJM


PROPOSED -ELEVATIONS -EXTERIOR

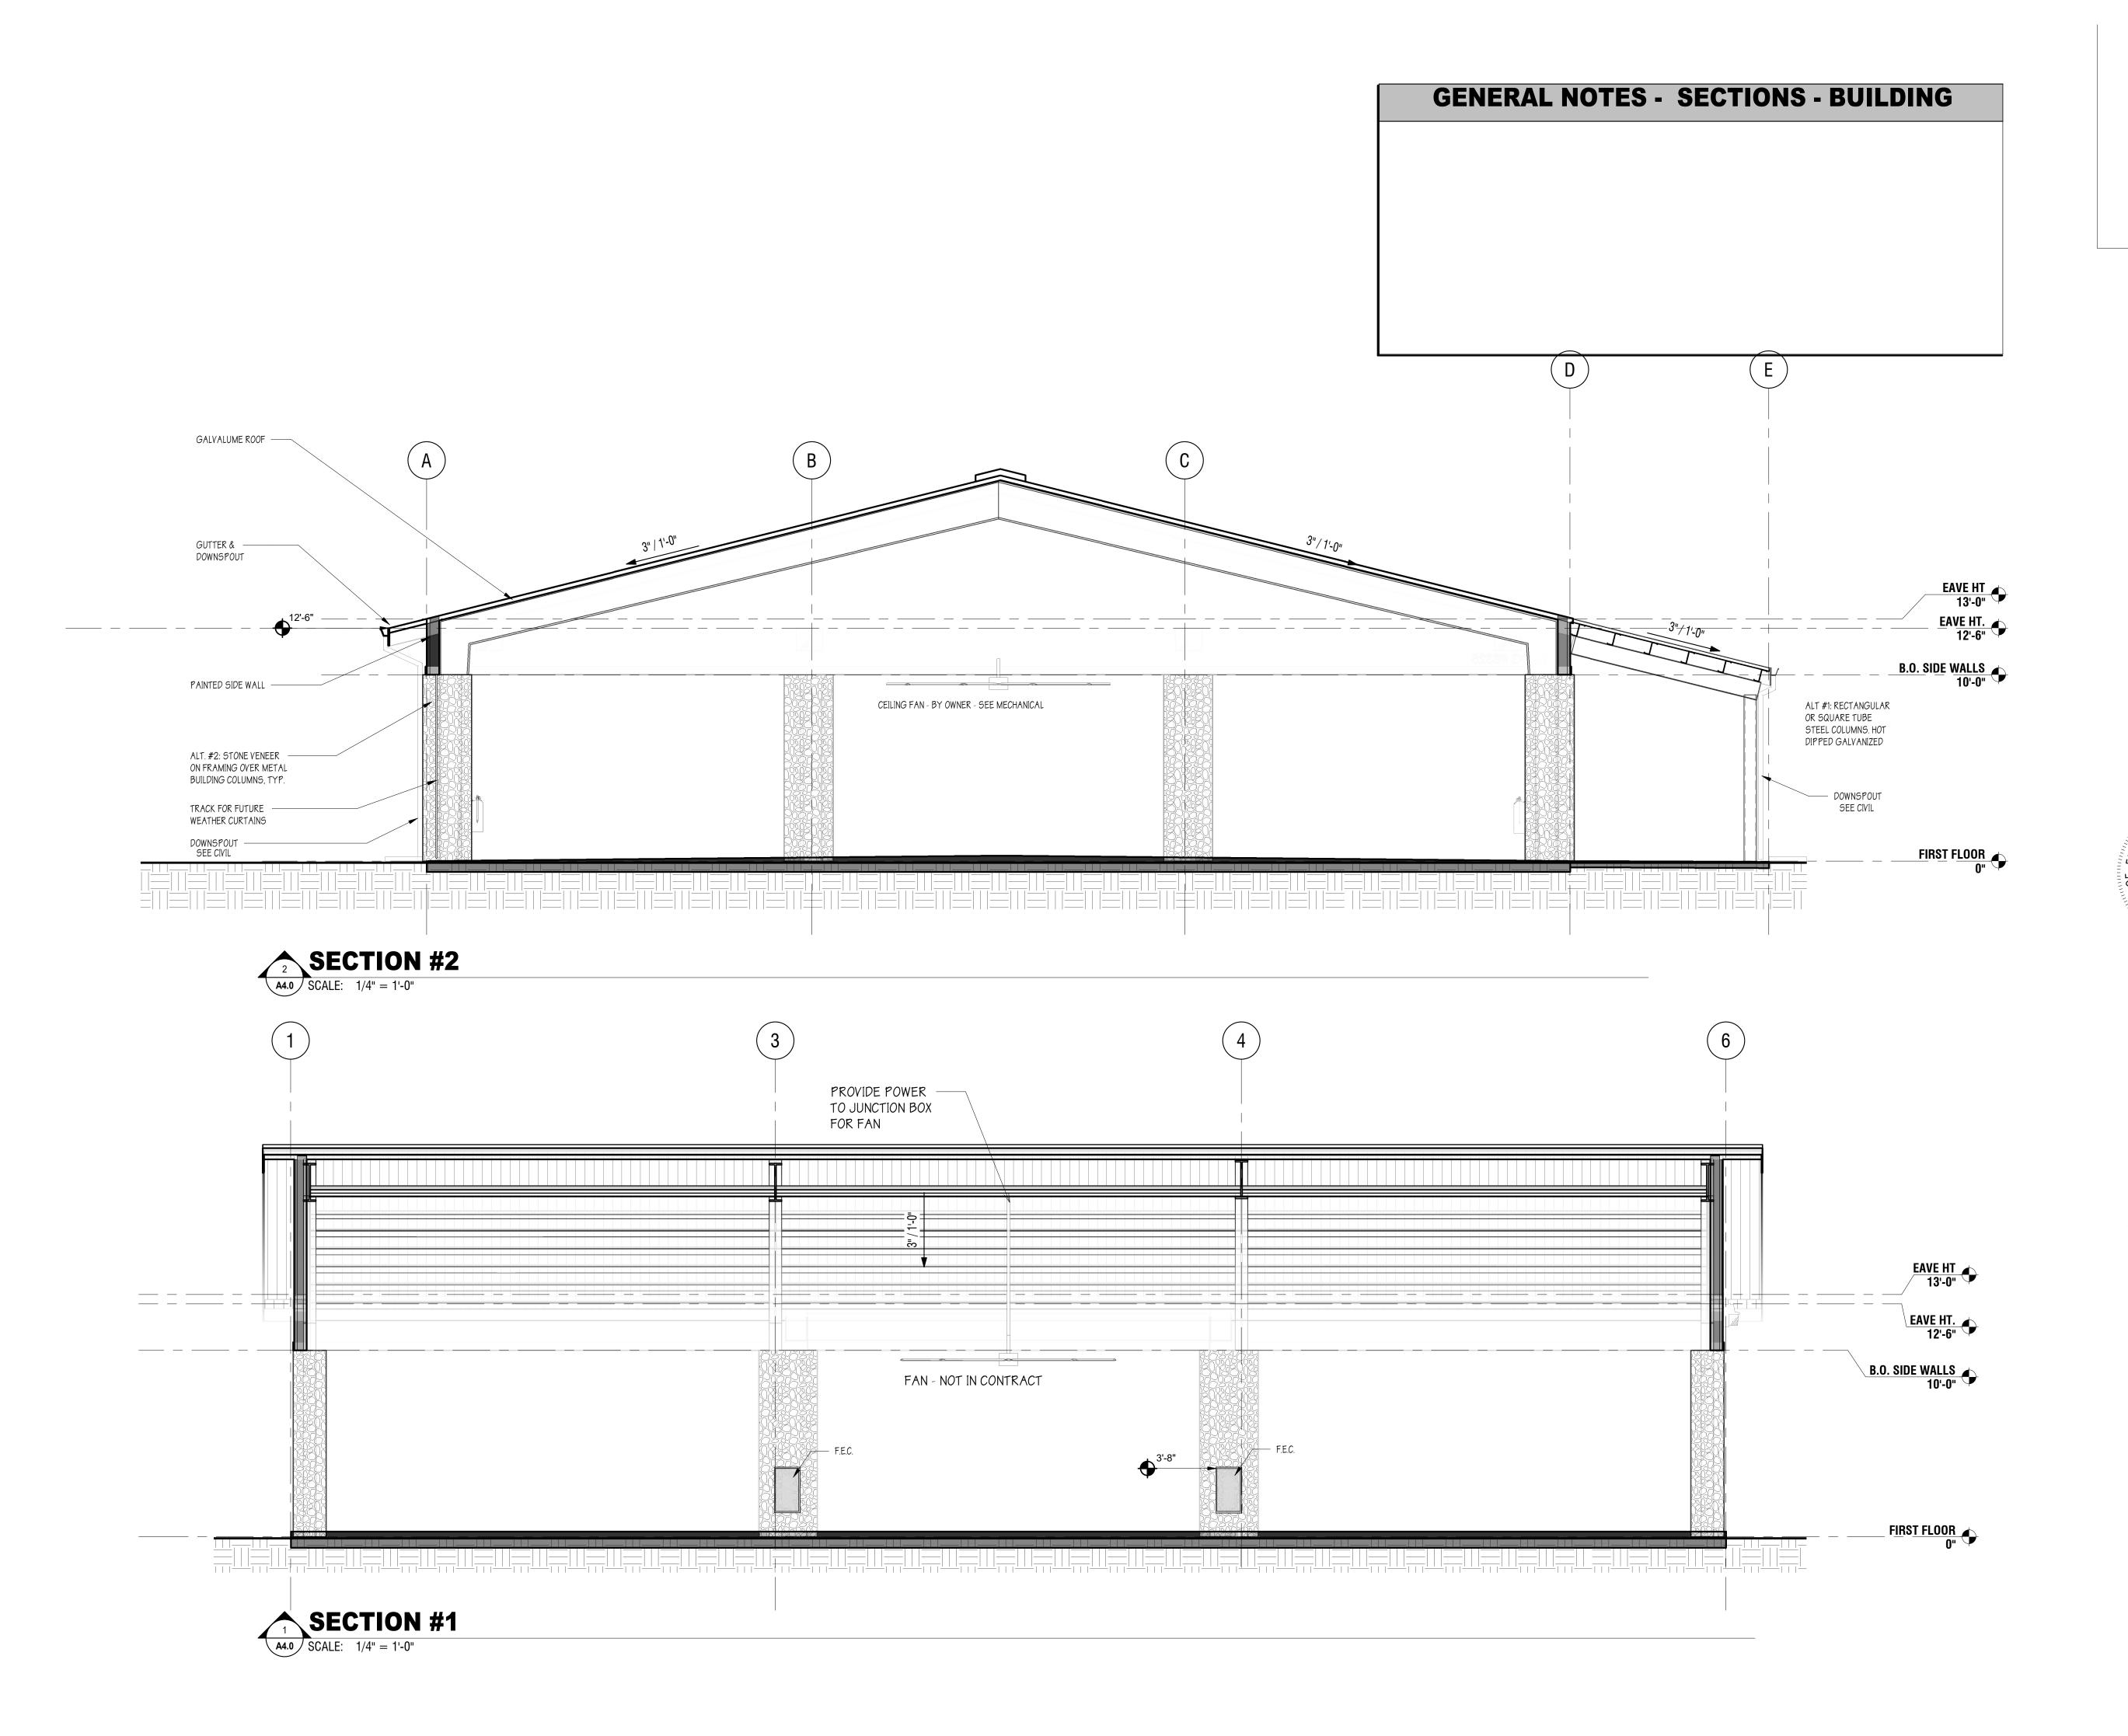

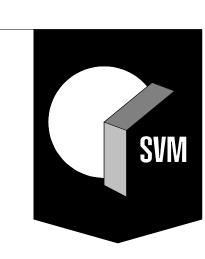

SKINNER VIGNOLA MCLEAN, INC. SVM

PLANNING, DESIGN CONSTRUCTION

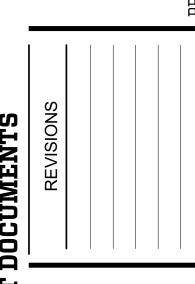


DATE: 03/12/2020
DRAWN BY: JER
CHECKED BY: HJM

PROPOSED -1460-30

PROPOSED - COLUMN SECTION PLAN

BOTTOM SECTION ALT. #2 STONE VENEER ON 4" METAL STUDS WEATHER BARRIER ON EXTERIOR GRADE SHEATHING ALL 4 SIDES EXTERIOR DOUBLE 4" GRADE METAL STUD SHEATHING ALIGN W/ BLDG FRAMING CONT. FLEXIBLE FLASHING OVER
3-1/2" CONT. METAL
FLASHING W/
HEMMED EDGE
-0'-4" COLUMN BEARING CONTINUOUS SEALANT BACKER ROD & SEALANT - CONCRETE PEDISTAL @ EACH COLUMN SIZE OF PEDISTAL W/ COLUMN SIZES & FRAMING

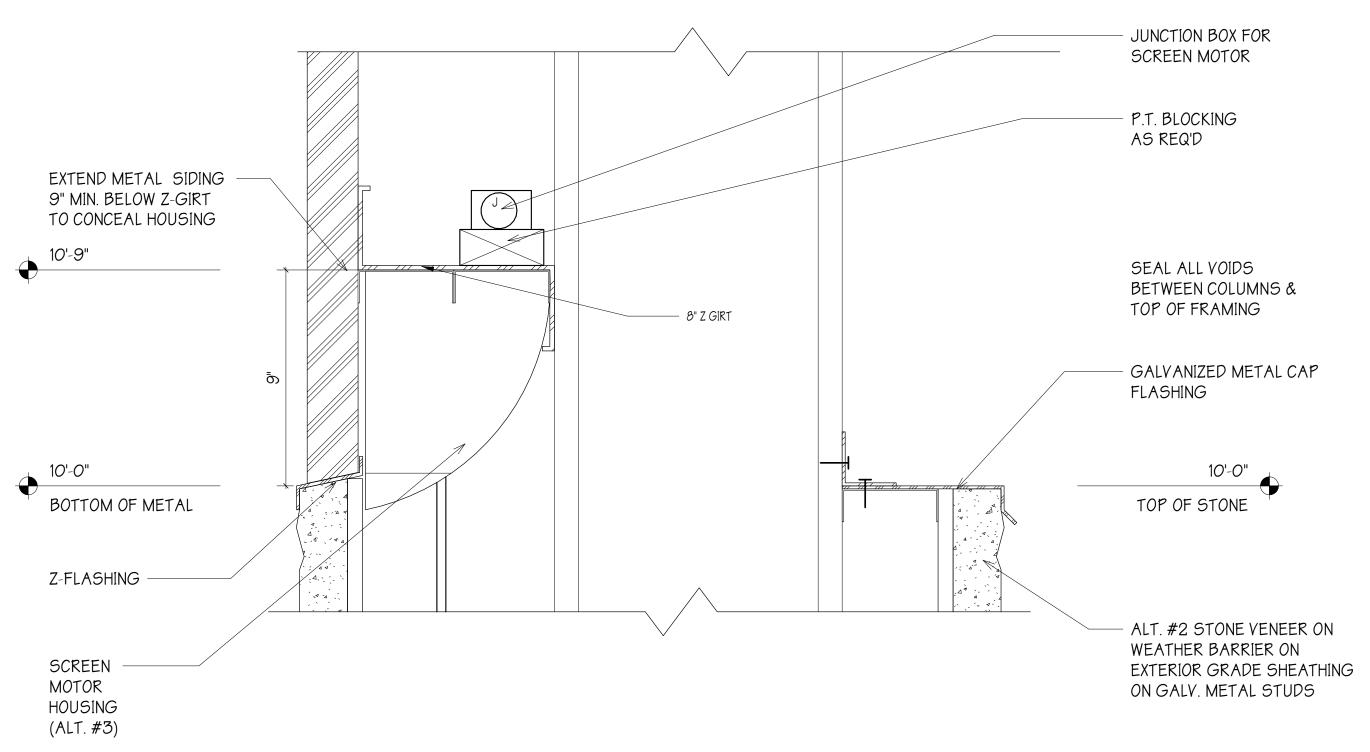

SKINNER VIGNOLA MCLEAN, INC. 1628 NW 6TH STREET GAINESVILLE FL 32609 SVM PLANNING, DESIGN CONSTRUCTION

DATE: 03/12/2020
DRAWN BY: JER
CHECKED BY: HJM

1460-30

PROPOSED -

SECTION @ TOP OF COLUMNS
SCALE: 3" = 1'-0"



March 24, 2020

Howard McLean Skinner Vignola McLean, Inc. 1628 NW 6th Street Gainesville, FL 32609

Re: Addendum

IFAS Live Oak Pavilion MG Project Number: 19096

Dear Howard:

Please issue the following as an addendum.

1. **SPECIFICATIONS**:

- a. Section 00 00 00 TABLE OF CONTENTS: Replace section in its entirety with the attached section indicating deleted section 26 41 00.
- b. Delete Section 26 41 00 LIGHTNING PROTECTION in its entirety.

2. DRAWINGS:

- a. Sheet E0.1 ELECTRICAL LEGEND, CODES, & ABBREVIATIONS: Replace sheet in its entirety with the attached 24"x36" sheet dated March 24, 2020.
- b. Sheet E1.2 ELECTRICAL CEILING PLAN LIGHTING: Replace sheet in its entirety with the attached 24"x36" sheet dated March 24, 2020.
- c. Delete Sheet E1.3 ELECTRICAL ROOF PLAN in its entirety.

Sincerely,

Craig Gulledge, PE, CxA, LEED AP BD+C

Principal

Attachments

TABLE OF CONTENTS

22 00 00	PLUMBING GENERAL
22 05 01	PLUMBING CODES AND STANDARDS
22 05 02	PLUMBING RELATED WORK
22 05 23	PLUMBING VALVES
22 10 00	PIPES AND FITTINGS
22 11 13	
22 13 16	SOIL WASTE AND VENT SYSTEM
22 24 00	TESTING, CLEANING, AND STERILIZATION OF PIPING SYSTEMS
00 00 00	ELECTRICAL CENERAL
26 00 00	ELECTRICAL GENERAL
26 05 01	ELECTRICAL CODES AND STANDARDS
26 05 02	ELECTRICAL RELATED WORK
26 05 26	GROUNDING AND BONDING
26 05 31	WIRES AND CABLES
26 05 33	RACEWAYS
26 05 34	BOXES AND FITTINGS
26 05 53	ELECTRICAL IDENTIFICATION
26 05 90	ELECTRICAL EXCAVATION AND BACKFILL
26 24 20	PANELBOARDS
26 27 26	GENERAL WIRING DEVICES
26 28 16	HEAVY DUTY SAFETY SWITCHES
26 41 00	LIGHTNING PROTECTION
26 56 00	EXTERIOR LIGHTING

MG Project Number: 19096

Mitchell Gulledge Engineering, Inc. 00 00 00 TABLE OF CONTENTS

THIS PAGE LEFT INTENTIONALLY BLANK

MG Project Number: 19096

208Y/120V FROM XFMR TPA


FROM MDP


EXAMPLE PANELBOARD/SWITCHBOARD LABEL


EXAMPLE MECHANICAL EQUIPMENT DISCONNECT LABEL

PROVIDE ENGRAVED PLASTIC TAG WITH 1/4" HIGH LETTERS. NORMAL POWER: BLACK LETTERS ON WHITE BACKGROUND. STANDBY POWER: WHITE LETTERS ON RED BACKGROUND. DIMENSIONS SHOWN ARE MINIMUM.


ELECTRICAL EQUIPMENT LABELING DETAIL

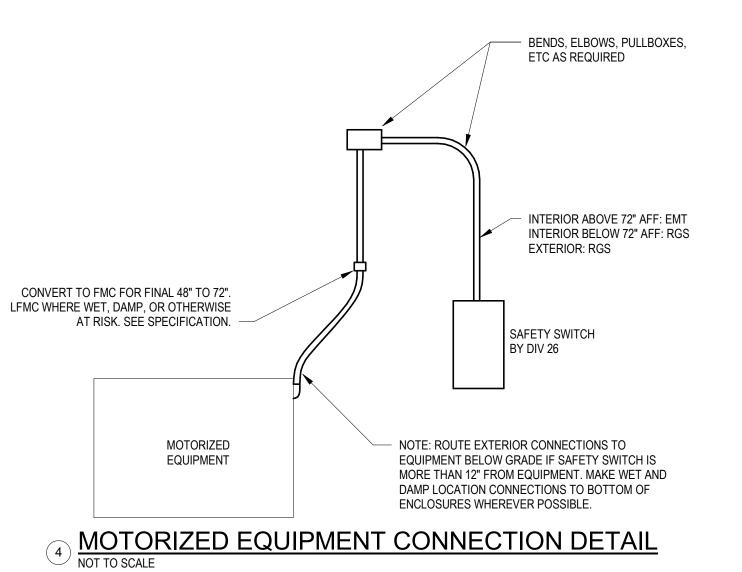

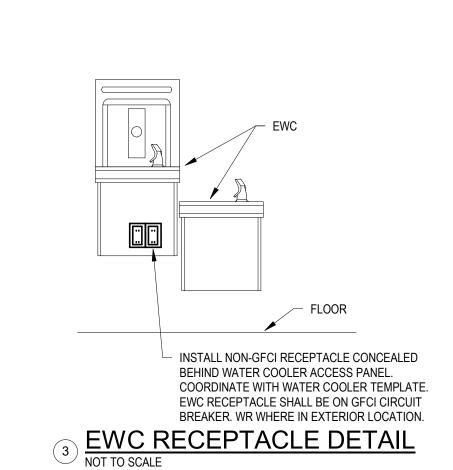

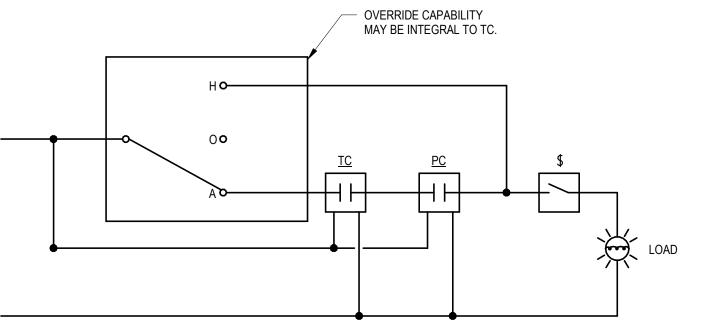

5 SINGLE-CIRCUIT EXTERIOR LIGHTING CONTROL DIAGRAM NOT TO SCALE

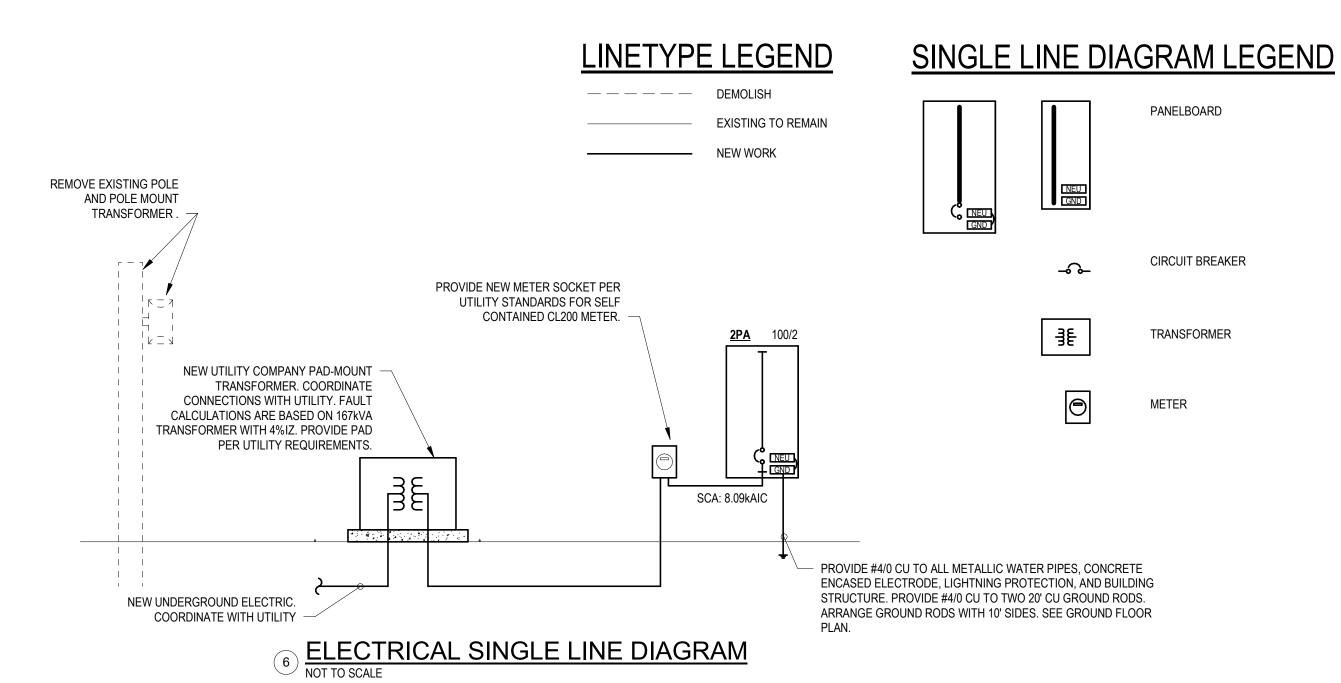

DUPLEX RECEPTACLE. 18" AFF UNO.

ABOVE COUNTER DUPLEX RECEPTACLE. 46" AFF UNO. COORDINATE WITH COUNTER, BACKSPLASH, ETC.

DUPLEX RECEPTACLE FACE DOWN IN CEILING.

SPECIAL PURPOSE RECEPTACLE. 18" AFF UNO. COORDINATE WITH EQUIPMENT.

RECEPTACLE SUBSCRIPTS:

GFCI-TYPE RECEPTACLE.

GCB GFCI-TYPE POWER FROM BRANCH CIRCUIT BREAKER.

EWC NON-GFCI RECEPTACLE ON GFCI CIRCUIT BREAKER. COORDINATE HEIGHT WITH EQUIPMENT WEATHER RESISTANT WIRING DEVICE. WP RECEPTACLES SHALL BE GFCI TYPE WITH IN-USE COVERS. 6-30R NEMA RECEPTACLE TYPE.

POWER EQUIPMENT AND CONNECTIONS: PANELBOARD.

ELECTRICAL CONNECTION TO EQUIPMENT. SEE ELECTRICAL EQUIPMENT SCHEDULE

JUNCTION BOX.

SAFETY SWITCH. MOUNT AS INDICATED. 60" TO TOP UNO.

FUSED SAFETY SWITCH. MOUNT AS INDICATED. 60" TO TOP UNO.

LIGHT FIXTURES: LIGHT FIXTURES SHALL BE AS INDICATED IN LIGHT FIXTURE SCHEDULE. SEE LIGHT FIXTURE SCHEDULE.

LOWERCASE LETTERS INDICATE SWITCHING/DIMMING ZONES. a,b LIGHT NOT SWITCHED BY OCCUPANCY SENSORS OR SWITCHES.

LIGHT FIXTURES SUBSCRIPTS:

PARTIAL SHADING OR 'EM' SUBSCRIPT INDICATES EMERGENCY FIXTURE. SEE LIGHT FIXTURE SCHEDULE.

LIGHTING CONTROLS:

TOGGLE SWITCH. 46" AFF UNO.

120/277V 20A PHOTOCELL. BOD: INTERMATIC EK4236S.

120/277V LIGHTING CONTACTOR. BOD: ENCLOSED SQUARE D CLASS 8903 WITH HOA SWITCH.

120/277V ASTRONOMICAL TIME CLOCK. BOD: INTERMATIC ET1125CR.

LIGHTING CONTROLS SUBSCRIPTS: 2-POLE TOGGLE SWITCH.

3-WAY TOGGLE SWITCH. 4-WAY TOGGLE SWITCH.

LOWERCASE LETTERS INDICATE SWITCHING/DIMMING ZONES.

TELECOMMUNICATIONS:

ROUGH-IN-ONLY TO. 18" AFF UNO. PROVIDE 1"C TO ABOVE ACCESSIBLE CEILING.

CEILING MOUNT TO ROUGH-IN.

TELECOMMUNICATIONS SUBSCRIPTS: CAM CAMERA TO.

WIRELESS ACCESS POINT TO.

ABOVE COUNTER **ANNOTATIONS**:

DEMOLITION SHEET NOTE.

ELECTRICAL SHEET NOTE.

MECHANICAL EQUIPMENT TAG.

GENERAL SUBSCRIPTS (APPLY TO ALL CATEGORIES):

<u>2P1A</u> ELECTRICAL EQUIPMENT TAG.

FED FROM GFCI TYPE CIRCUIT BREAKER.

INDICATES HEIGHT OF FIXTURE, RECEPTACLE, BOX, CABINET, ETC. HEIGHT IS TO CENTERLINE UNLESS OTHERWISE INDICATED.

EX EXISTING TO REMAIN

WEATHERPROOF INSTALLATION, WITH APPROPRIATELY LISTED OR INDICATED PRODUCTS.

ELECTRICAL HOME RUN TO PANELBOARD. UNDERLINED LABEL INDICATES PANELBOARD NAME AND CIRCUIT NUMBER. UNLESS INDICATED OTHERWISE

DEFAULT WIRING IS #12 & #12G. PROVIDE CONDUCTORS AS NEEDED FOR INDICATED SWITCHED LEGS, ZONES, ETC. SEE ELECTRICAL EQUIPMENT

SCHEDULE FOR SPECIFIC CIRCUIT SIZING.

ABBREVIATIONS

- ACS (ELECTRONIC) ACCESS CONTROL SYSTEM AWG AMERICAN WIRE GAUGE
- BOD BASIS OF DESIGN
- CONDUIT CAMERA
 - CIRCUIT BREAKER CONTRACTOR FURNISHED, CONTRACTOR INSTALLED
- CONTRACTOR FURNISHED, OWNER INSTALLED
- COMBINATION MOTOR STARTER
- CARBON MONOXIDE
- DIVISION
- ENCLOSED CIRCUIT BREAKER
- ENGINEER OF RECORD EOR ELECTRIC WATER COOLER
- EXISTING TO REMAIN
- FUSED SAFETY SWITCH GROUND, GROUND FAULT CIRCUIT INTERRUPTER
- GFCI CIRCUIT BREAKER
- LTG LIGHTING LTS LIGHTS
- - MOTOR CONTROL CENTER NOTIFICATION APPLIANCE CIRCUIT
- OWNER FURNISHED, CONTRACTOR INSTALLED OWNER FURNISHED, OWNER INSTALLED
- PANELBOARD POWER QUALITY METER PQM
- SURGE PROTECTION DEVICE
- SIGNALING LINE CIRCUIT SAFETY SWITCH
- SWBD SWITCHBOARD TO BE DETERMINED
- TELECOMMUNICATIONS ROOM
- TELECOMMUNICATIONS OUTLET TYPICAL
- UNIVERSITY OF FLORIDA UNIVERSITY OF FLORIDA
- UNLESS NOTED OTHERWISE VARIABLE FREQUENCY DRIVE VFD
- WORK AREA OUTLET WIRELESS ACCESS POINT
- WEATHER PROOF / WEATHER RESISTANT
- WEATHER PROOF / WEATHER RESISTANT WRT WITH RESPECT TO

CODES AND STANDARDS

ALL PROJECT WORK SHALL BE GOVERNED BY AND ADHERE TO THE FOLLOWING CODES AND STANDARDS.

- FLORIDA BUILDING CODE SIXTH EDITION (2017) FLORIDA BUILDING CODE - SIXTH EDITION (2017) - ENERGY CONSERVATION
- FLORIDA FIRE PREVENTION CODE SIXTH EDITION (2017)
- A. FIRE CODE (NFPA 1 2015 FLORIDA EDITION) LIFE SAFETY CODE (NFPA 101 - 2015 FLORIDA EDITION)
- NATIONAL ELECTRIC CODE (2014 NFPA 70).
- UNDERWRITERS' LABORATORIES (UL)
- AMERICAN NATIONAL STANDARDS INSTITUTION (ANSI) AMERICAN SOCIETY OF TESTING MATERIALS (ASTM)
- NATIONAL FIRE PROTECTION ASSOCIATION (NFPA)
- NATIONAL ELECTRICAL MANUFACTURERS ASSOCIATION (NEMA
- INSTITUTE OF ELECTRICAL AND ELECTRONICS ENGINEERS (IEEE) NATIONAL ELECTRICAL CONTRACTORS ASSOCIATION (NECA)
- AMERICAN SOCIETY OF HEATING, REFRIGERATING AND AIR-CONDITIONING ENGINEERS (ASHRAE) SHEET METAL AND AIR CONDITIONING CONTRACTORS' NATIONAL ASSOCIATION (SMACNA)
- ILLUMINATING ENGINEERING SOCIETY OF NORTH AMERICA (IESNA) TELECOMMUNICATIONS INDUSTRY ASSOCIATION (TIA)


ELECTRONICS INDUSTRY ALLIANCE (EIA)

- **GENERAL DEMOLITION NOTES**
- ALL CIRCUITS AND SYSTEMS OUTSIDE OF THE PROJECT AREA ARE TO REMAIN IN SERVICE AT ALL TIMES THROUGHOUT THE WORK. COORDINATE ANY NECESSARY OUTAGES WITH OWNER PRIOR TO
- DEMOLISH ALL FIXTURES AND CIRCUITS AS INDICATED. DEMOLISH ALL ASSOCIATED WIRES, RACEWAY, AND BOXES. MAINTAIN FUNCTIONALITY OF ALL REMAINING FIXTURES AND EQUIPMENT.
- DEMOLISH ANY SYSTEMS AND APPURTENANCES DISCOVERED WITHIN WALLS BEING DEMOLISHED. WHERE THESE SYSTEMS SERVE AREAS OUTSIDE OF THE PROJECT AREA, COORDINATE WITH OWNER, ARCHITECT, AND ENGINEER TO MAINTAIN EXISTING FUNCTIONALITY IN A WAY COMPATIBLE WITH THIS PROJECT.

NEC ELECTRICAL LOAD CALCULATION: PANEL 2PA (240Y/120V 1Ø 3W)						
LOAD DESCRIPTION	PER UNIT LOAD	UNITS	CONNECTED LOADS	ADJUSTMENT FACTOR	NEC 220 CALC LOAD	NOTES
HIGH VOLUME LOW VELOCITY FANS	7200.0 VA ea	1	7.2 kVA	1.25	9.0 kVA	
LIGHTING	73 VA ea	16	1.168 kVA	1.25	1.46 kVA	
LIGHTING	29 VA ea	4	0.116 kVA	1.25	0.145 kVA	
LIGHTING	41 VA ea	2	0.082 kVA	1.25	0.103 kVA	
EWC	600 VA ea	1	0.6 kVA	1.00	0.6 kVA	
RECEPTACLES	180 VA ea	12	2.16 kVA	1.00	2.16 kVA	
TOTALS (kVA)			11.326 kVA		13.468 kVA	
TOTALS (A)			47.19 A		56.11 A	



FL License EB-31501 p.352.745.3991 www.mitchellgulledge.com MG#19096

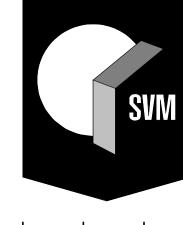

McLEAN, INC

VIGNOLA SKINNER SVM

TION

B DATE: **03/02/2020** S DRAWN BY: CHECKED BY: APM

ELECTRICAL ABBREVIATIONS

LIGHT FIXTURE SCHEDULE									
TYPE	DESCRIPTION	BASIS OF DESIGN	LIGHT SOURCE	INITIAL LUMENS	COLOR TEMPERATURE	WATTAGE	VOLTAGE	MOUNTING	NOTES
4VPL	4' VAPORTIGHT LED WRAP	H.E. WILLIAMS 96-4-L62/840-PCFR-DRV-UNV	LED	6200 lm	4000 K	73 VA	120 V	MOUNT TO PURLINS	MOUNT TO STRUCTURE.
BOL	LED BOLLARD WITH EMERGENCY BATTERY	GARDCO PBL-36-14L-800-NW-G2-3-EBP-120-F1-FINISH	LED	3198 lm	4000 K	41 VA	120 V	POLE IN GROUND	COORDINATE FINISH WITH ARCHITECT. PROVIDE EMERGENCY BATTERY WITH FIXTURE. BATTERY SHALL BE RATED FOR 4°F.
FLD	LED EXTERIOR FLOOD LIGHT WALL MOUNT	PHILLIPS GARDCO CSFS-16-530-NW-G1-YK-A33-120-BK WITH BP-(F)	LED	3025 lm	4000 K	29 VA	120 V	WALL AT 9'	PROVIDE BP-(F) SURFACE MOUNT BASE PLATE.
XEB	EDGE LIT LED EXIT SIGN	BEGHELLI FTZ-SA-LG-IH	LED			2 VA	120 V		WET LOCATION & RATED FOR 0 DEGREES FAHRENHEIT


NOTES:


1. SUBMIT ALTERNATES TO A/E FOR CONSIDERATION A MINIMUM OF 10 BUSINESS DAYS PRIOR TO BID. SUBMIT FIXTURE "CUT SHEET", INDICATING ALL INTENDED RATINGS AND OPTIONS.

2. A/E WILL REVIEW ALTERNATES TO DETERMINE IF THEY ARE FUNCTIONALLY, AESTHETICALLY, AND STRUCTURALLY EQUAL. A/E RESERVE THE RIGHT TO REJECT ANY FIXTURES WHICH ARE NOT DEEMED EQUAL TO THE BASIS OF DESIGN.

3. ALTERNATES REJECTED BY A/E SHALL NOT RESULT IN ADDITIONAL CHARGES TO THE OWNER.

4. FIXTURES HALF SHADED OR MARKED 'EM' ON THE PLANS SHALL BE PROVIDED WITH BODINE BATTERIES PROVIDING AT LEAST 700lm OUTPUT FOR AT LEAST 90 MINUTES.

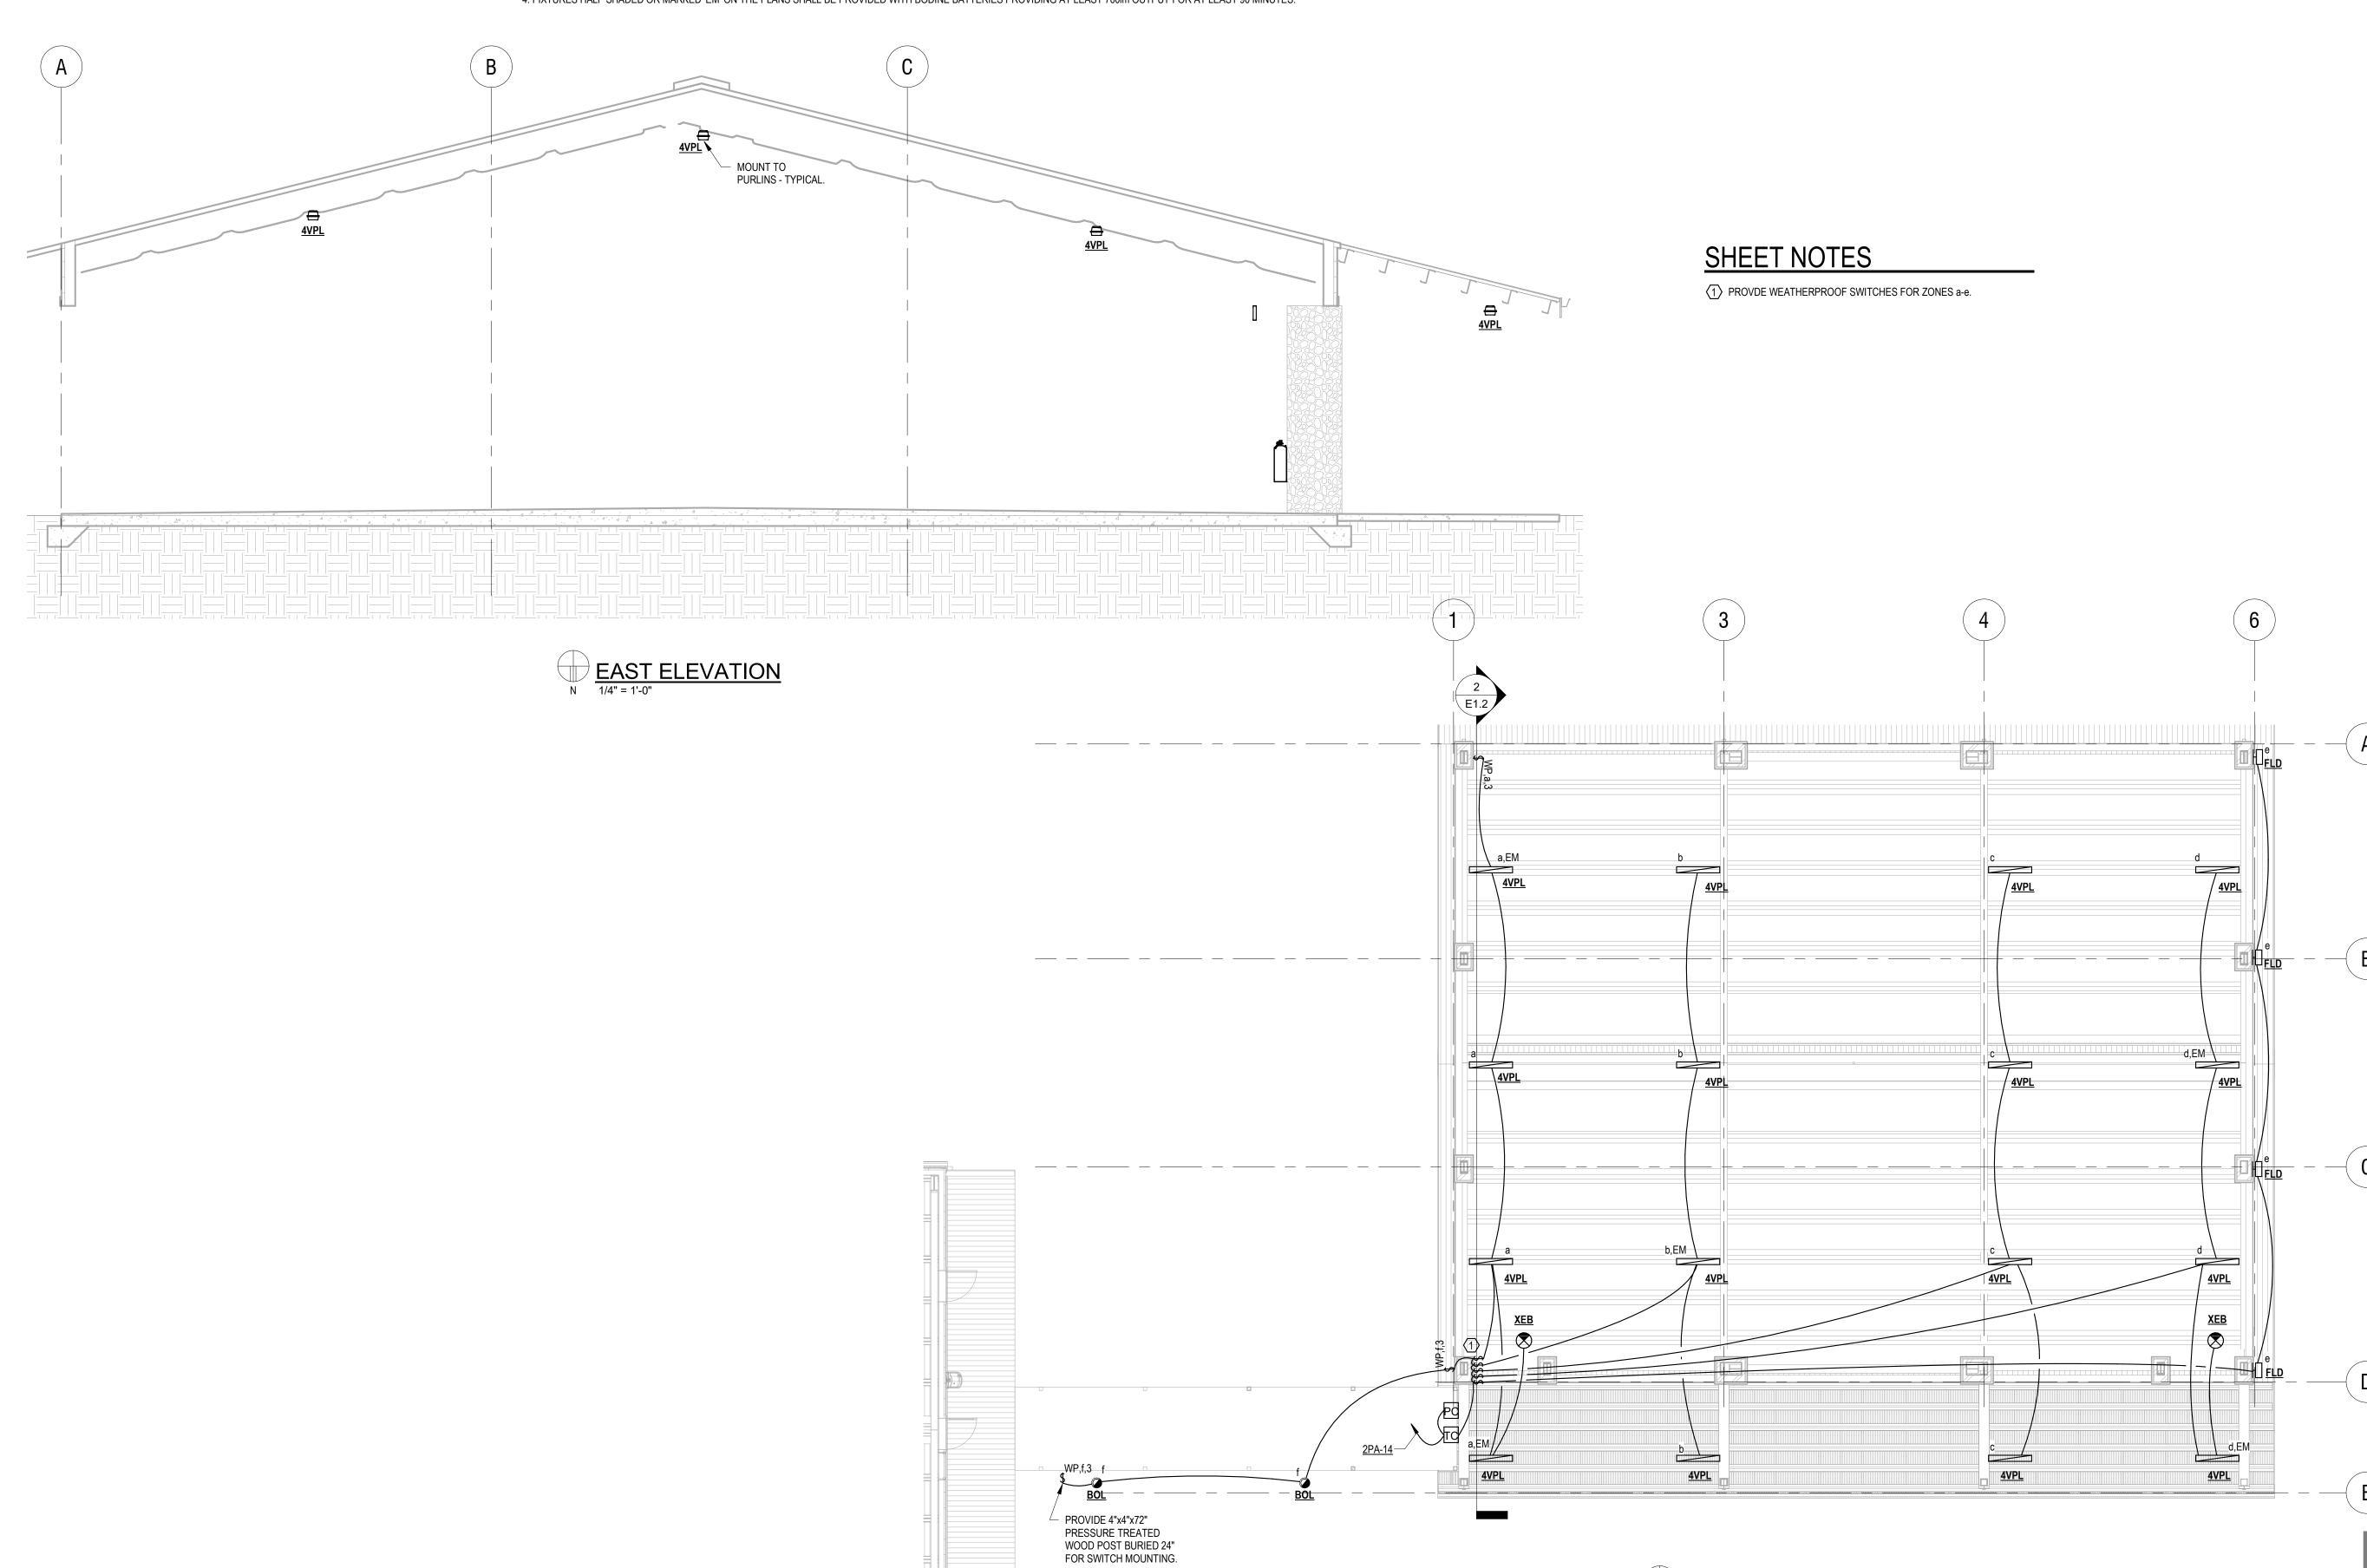

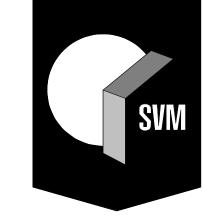

SKINNER VIGNOLA MCLEAN, INC.

UF/IFAS 20038 NORTH FLORIDA REC - LIVE OAK AGRICULTURE DEMONSTRATION BUILDING FOR UF PLANNING, DESIGN & CONSTRUCTION LIVE OK, FL 32

DATE: 03/02/2020
PRAWN BY: BNF
CHECKED BY: APM ELECTRICAL CEILING PLAN

LIGHTING

engineering Mitchell Gulledge Engineering, Inc. 210 SW 4th Avenue Gainesville, FL 32601 FL License EB-31501 p.352.745.3991 www.mitchellgulledge.com MG#19096

ELECTRICAL CEILING PLAN - LIGHTING

1/8" = 1'-0"